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PERMIT SET

Drawing Title:
PARTIAL FIRST FLOOR -
PLUMBING PLANS

Project No. 2307 Date: 1/12/2024

Sheet No.
P3.2

NOTES BY SYMBOL "T"


- ① 1/2-INCH COLD WATER TO PLUMBING FIXTURE; 1 1/2 VENT UP, 2-INCH WASTE DOWN.
- ② 1/2-INCH COLD WATER TO IWH AND EACH LAVATORY; ROUTE 1/2-INCH HOT WATER FROM IWH TO EACH LAVATORY. REFER TO DETAIL 5/P4.1 FOR ADDITIONAL INSTRUCTIONS.
- ③ 2-INCH WASTE FROM PLUMBING FIXTURE; 1 1/2-INCH VENT UP.
- ④ 2-INCH WASTE FROM BELOW.
- ⑤ 2-INCH WASTE DOWN, 2-INCH VENT UP WITH CLEAN-OUT AT BASE OF RISER.
- ⑥ 1/2-INCH COLD WATER TO PLUMBING FIXTURE.
- ⑦ 1/2-INCH COLD WATER UP TO PLUMBING FIXTURE. REFER TO P2.2 FOR ADDITIONAL INSTRUCTIONS.
- ⑧ REFER TO P2.1 FOR CONTINUATION.

GENERAL NOTES THIS SHEET


- 1. REFER TO PD.1 FOR ADDITIONAL INSTRUCTIONS.
- 2. COORDINATE ALL PLUMBING WITH OWNER/ARCHITECT PRIOR TO PURCHASING THE FIXTURE.

NOTES BY SYMBOL "T"

- ① 3-INCH VENT FROM BELOW
- ② 3/4-INCH HOT AND COLD WATER DOWN TO PLUMBING FIXTURE; 2-INCH VENT FROM BELOW.
- ③ 1 1/2-INCH COLD WATER TO PLUMBING FIXTURE; 2-INCH VENT FROM BELOW.
- ④ 1/2-INCH HOT AND COLD WATER TO PLUMBING FIXTURE; 2-INCH WASTE DOWN, 1 1/2-INCH VENT UP. REFER TO DETAIL 2/P4.1 FOR ADDITIONAL INSTRUCTIONS.
- ⑤ 1/2-INCH HOT AND COLD WATER TO PLUMBING FIXTURE; 2-INCH WASTE DOWN, 1 1/2-INCH VENT UP.
- ⑥ 2-INCH COLD CONDENSATE FROM ABOVE; TURN OUT FROM WALL AND DOWN TO DISCHARGE INDIRECTLY AT MOP SINK.
- ⑦ 3/4-INCH COLD WATER AND 1-INCH GAS (120 MBH) TO IWH-PH-1; 3/4-INCH HOT WATER FROM IWH-PH-1. PROVIDE REGULATOR IN GAS LINE TO MAINTAIN GAS PRESSURE WITHIN MANUFACTURER'S MINIMUM AND MAXIMUM GAS PRESSURES (DESIGN BASIS UNIT - 4/10.5 INCHES WATER COLUMN MIN/MAX RESPECTIVELY). REFER TO DETAIL 4/P4.1 FOR ADDITIONAL INSTRUCTIONS.
- ⑧ ROUTE FULL-SIZE WASTE FROM EACH BASIN OF KITCHEN FIXTURE TO DRAIN INDIRECTLY AT FLOOR SINK.
- ⑨ 1/2-INCH HOT AND COLD WATER DOWN TO PLUMBING FIXTURE (BY OTHERS); 2-INCH VENT FROM BELOW.
- ⑩ 1/2-INCH COLD WATER DOWN TO FILTRATION SYSTEM FOR EQUIPMENT (BEVERAGE- OR OR ICE-MACHINE). PROVIDE REDUCED PRESSURE ZONE ASSEMBLY (RPZA) WHERE BACKFLOW PREVENTION IS NOT INTEGRAL TO EQUIPMENT.
- ⑪ ROUTE FULL SIZE EQUIPMENT DRAIN (ICE-MAKER OR DISHWASHER) INDIRECTLY TO NEAREST FLOOR SINK.
- ⑫ 1/2-INCH GAS UP TO EQUIPMENT ON ROOF. REFER TO P2.2 FOR CONTINUATION AND ADDITIONAL INSTRUCTIONS.
- ⑬ EXTEND 3/4-INCH GAS FROM 1-INCH GAS LINE IN ADJACENT ATTIC SPACE.
- ⑭ 3-INCH VENT THROUGH ROOF.
- ⑮ 1/2-INCH COLD AND HOT WATER DOWN IN WALL TO PLUMBING FIXTURE; 2-INCH VENT FROM BELOW. REFER TO DETAIL 5/P4.1 FOR ADDITIONAL INSTRUCTIONS.
- ⑯ 1/2-INCH COLD AND HOT WATER FROM BELOW; 2-INCH VENT DOWN. REFER TO DETAIL 5/P4.1 FOR ADDITIONAL INSTRUCTIONS.
- ⑰ 2-INCH VENT FROM BELOW (FLOOR SINK)
- ⑱ 1/2-INCH GAS (293 MBH) DOWN TO GAS MANIFOLD FOR KITCHEN EQUIPMENT. REFER TO FOOD SERVICE EQUIPMENT VENDOR DRAWINGS FOR ADDITIONAL INSTRUCTIONS AND CONNECTION TO EQUIPMENT.
- ⑲ 3/4-INCH COLD WATER TO PLUMBING FIXTURE; 2-INCH WASTE DOWN, 2-INCH VENT UP.

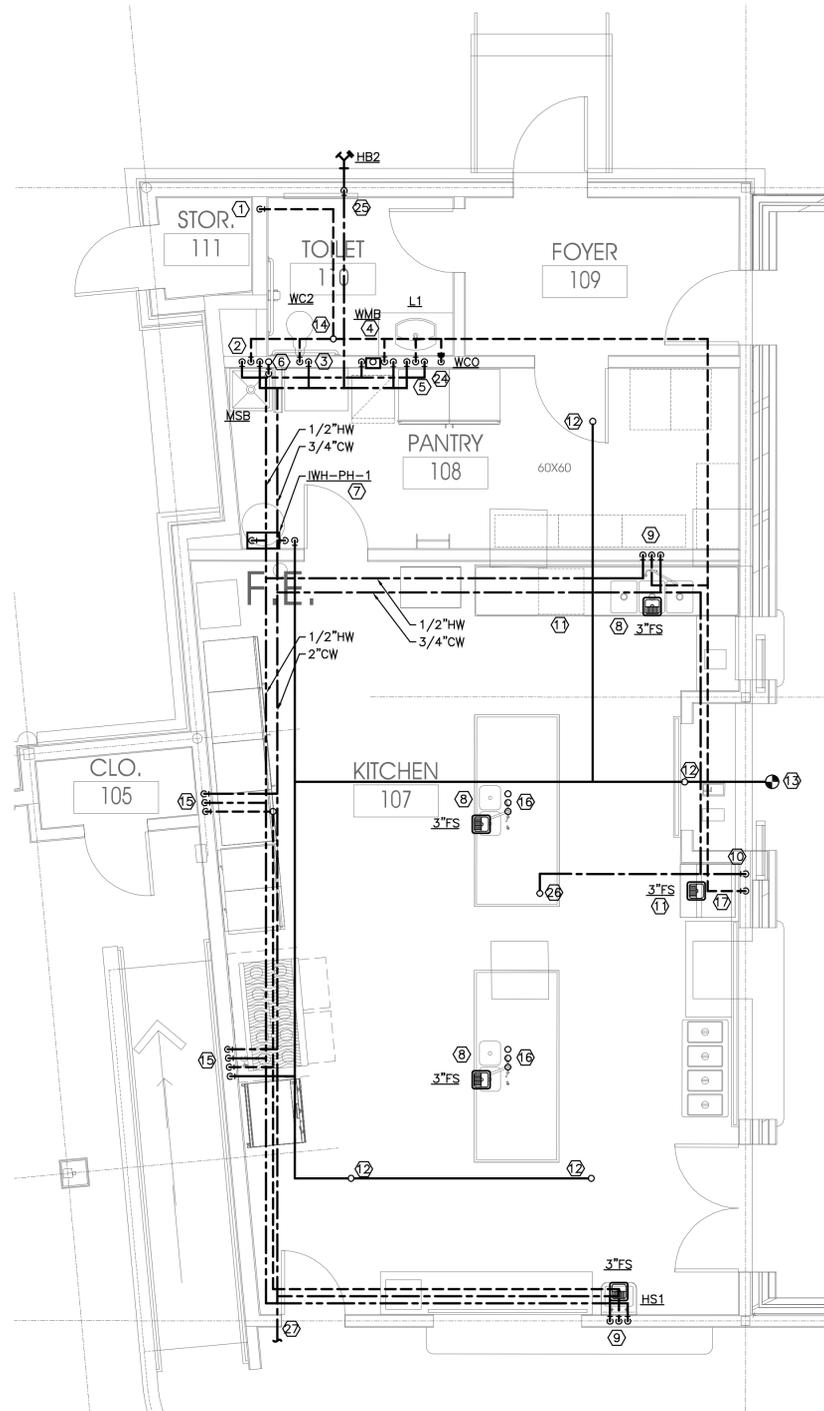

1 PARTIAL FLOOR - ENLARGED KITCHEN - PLUMBING PLAN
Scale: 1/4" = 1'-0"

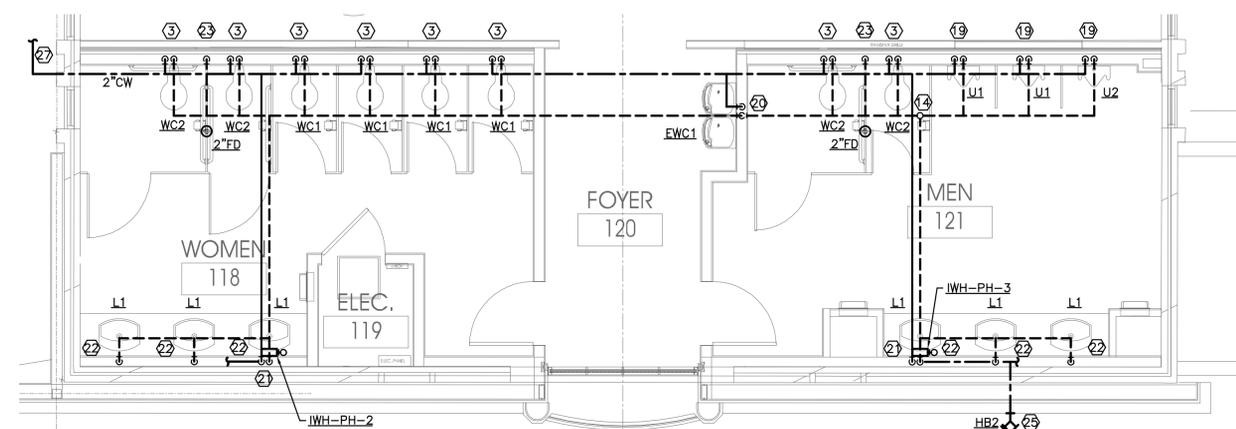

1 PARTIAL FLOOR - ENLARGED RESTROOM - PLUMBING PLAN
Scale: 1/4" = 1'-0"



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