
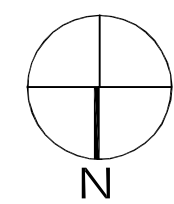


C:\Work\Projects\23-47 St. Jude CC - Parish Hall Addn\Mech\2347-M22.dwg 12/20/23 16:37:07 Rene's ASUS

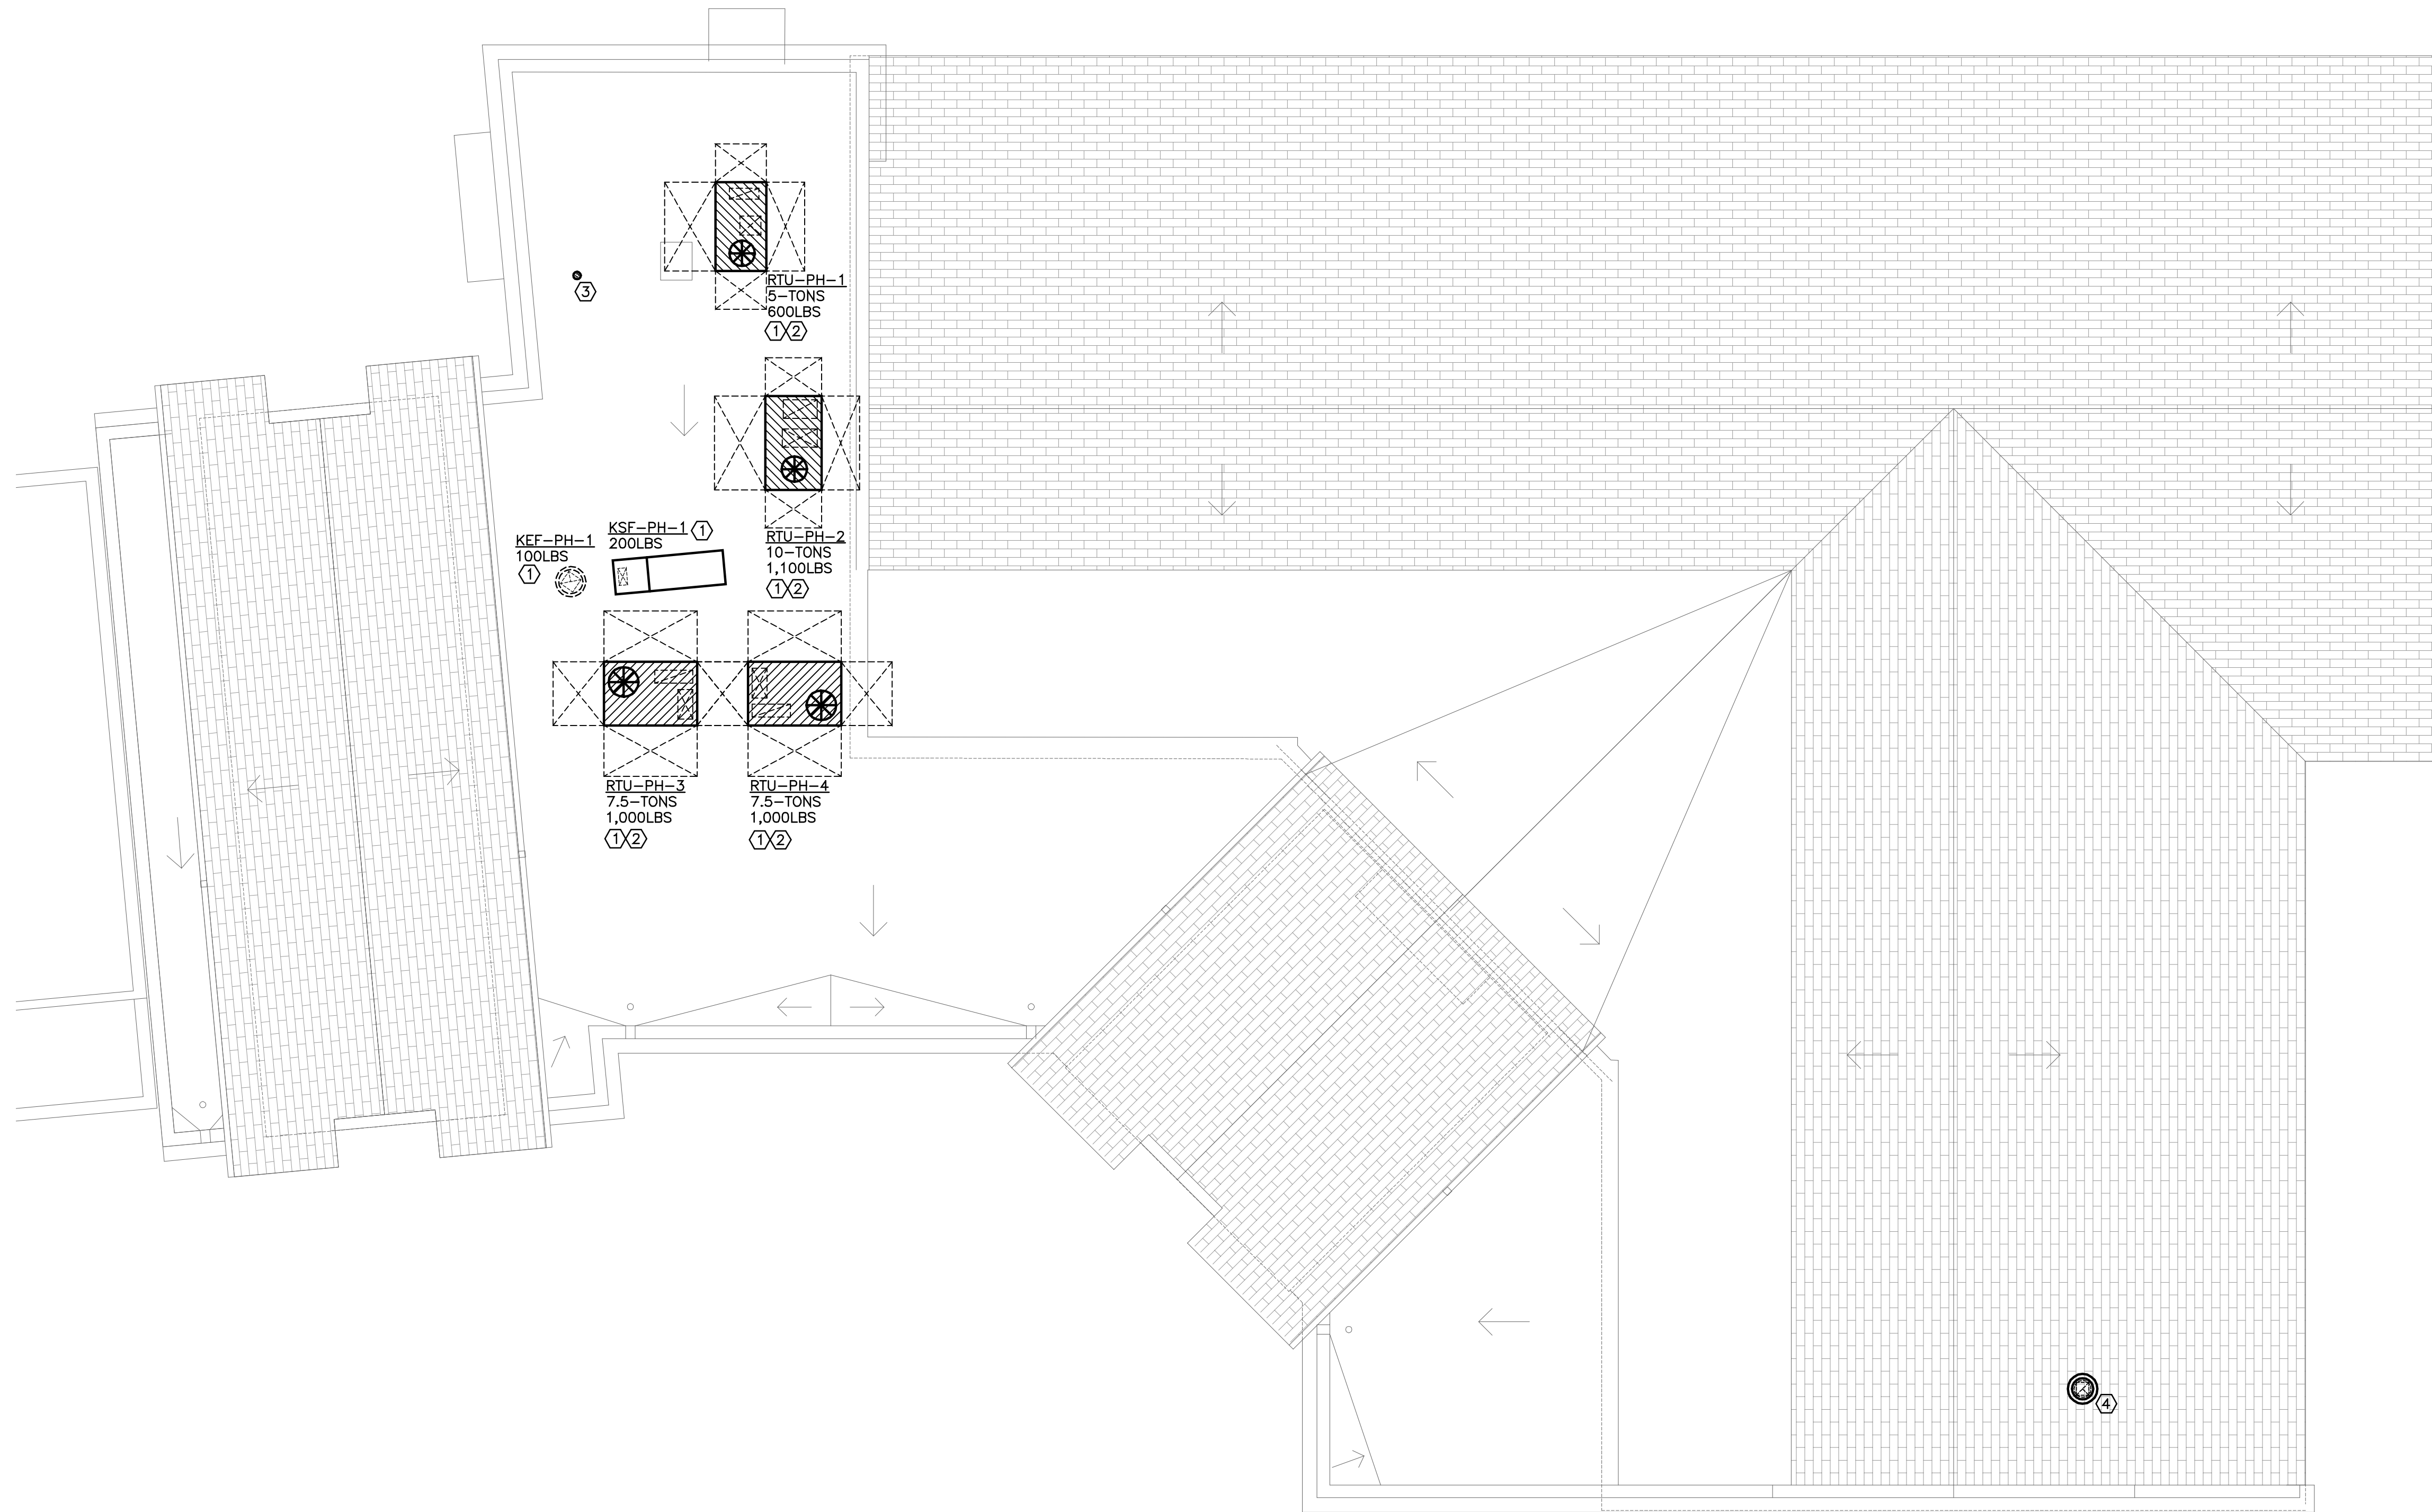

PARTIAL ROOF - HVAC PLAN

Scale: 1/8" = 1'-0"


NOTES BY SYMBOL "1"

- TRANSITION TO/FROM FULL-SIZE EQUIPMENT OPENING FROM/TO SIZE SHOWN ON PLAN AT ROOF DECK. REFER TO M3.1 FOR ADDITIONAL INSTRUCTIONS.
- MAINTAIN MANUFACTURER'S RECOMMENDED SERVICE AND AIR FLOW CLEARANCES.
- CONCENTRIC VENT THROUGH ROOF. REFER TO DETAIL 8/M4.1 FOR ADDITIONAL INSTRUCTIONS.
- EXHAUST HOOD EQUAL TO LOREN COOK PR16 WITH FACTORY BIRD SCREEN, CURB WITH BOTTOM SLOPED TO MATCH ROOF SLOPE, AND BACK-DRAFT DAMPER. TRANSITION FROM DUCT SIZE SHOWN ON FLOOR PLAN (M2.1) TO FULL-SIZE EQUIPMENT OPENING SIZE ROOF DECK. COORDINATE LOCATION WITH EXISTING FLUE VENT LOCATIONS AND TO BE WITHIN VOID SPACE BETWEEN ROOF STRUCTURAL JOIST/RAFTERS.

GENERAL NOTES THIS SHEET

- REFER TO NOTES ON M0.1 FOR ADDITIONAL INSTRUCTIONS.
- MAINTAIN 10-FEET SEPARATION BETWEEN OUTDOOR AIR INTAKE LOCATIONS AND ANY PLUMBING OR FLUE VENT OR EXHAUST AIR DISCHARGE AIR LOCATIONS.

8' 0 8' 16'
1/8"=1'-0"

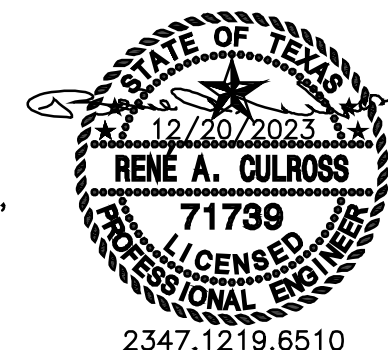

MEP Consultant
Rene' A. Culross
Rene' A. Culross, P.E., PLLC
1820 Hunting Green Drive
Fort Worth, TX 76134
817-798-6642
raculross@gmail.com
F-12230

ARCHITECTURE
SCOTT MARTSOLF - ARCHITECT

815 Daggett Avenue
Fort Worth, Texas 76104
Phone: (817) 820-0005

ST. JUDE
CATHOLIC
CHURCH

PARISH HALL
REMODEL &
CONNECTOR
BUILDING

500 E DALLAS ST.
MANSFIELD, TX 76063

BID SET

Drawing Title:

PARTIAL ROOF
HVAC PLAN

Project No.

2307

Date:

12/20/2023

Sheet No.

M2.2