



ARCHITECTURE SCOTT MARTSOLF - ARCHITECT 815 Daggett Avenue Fort Worth, Texas 76104 Phone: (817) 820-0005

ST. JUDE CATHOLIC CHURCH PARISH HALL REMODEL & CONNECTOR

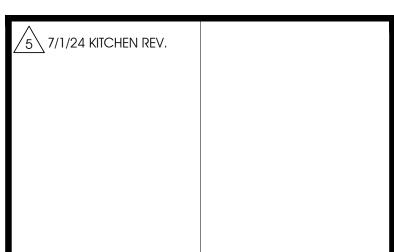

500 E DALLAS ST.

| Drawing Title: KITCHEN - ENL | ARGED PLANS |
|---------------------------------|-------------|
| Project No. | Date: |
| 2307 | 1/12/2024 |
| ERED ARCHINA | Sheet No. |
| | A5.1 |

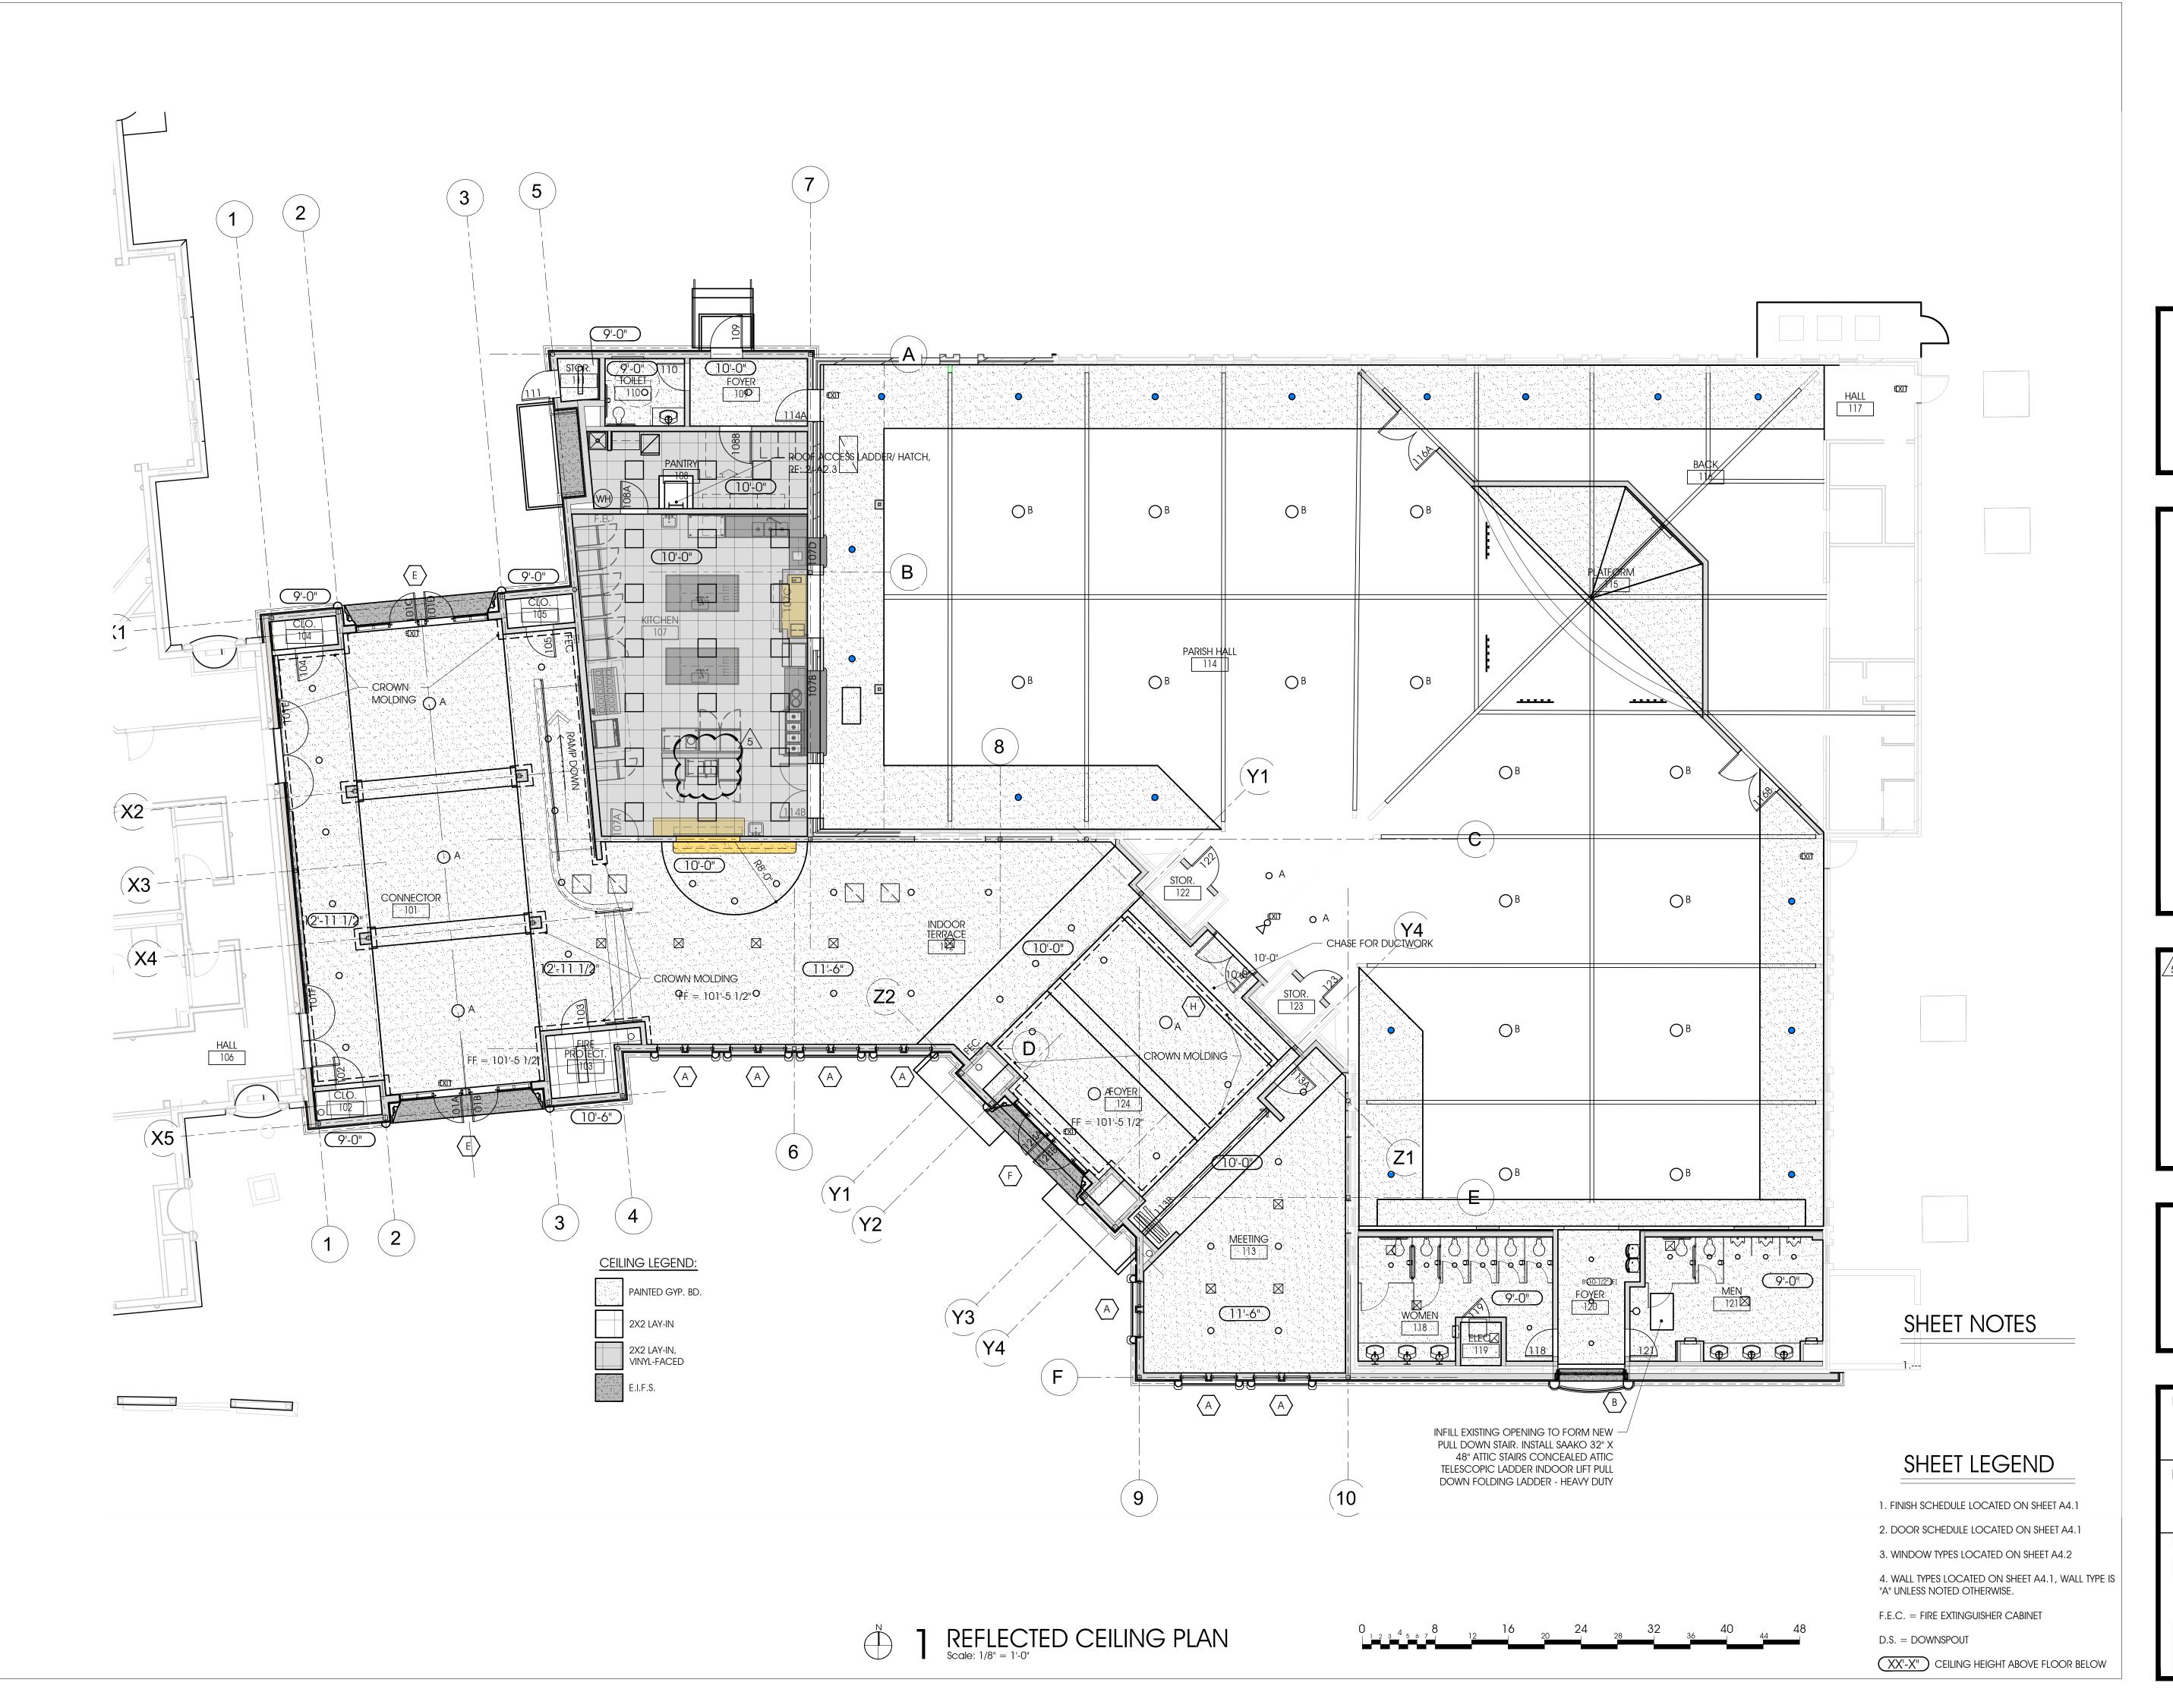


ARCHITECTURE SCOTT MARTSOLF - ARCHITECT

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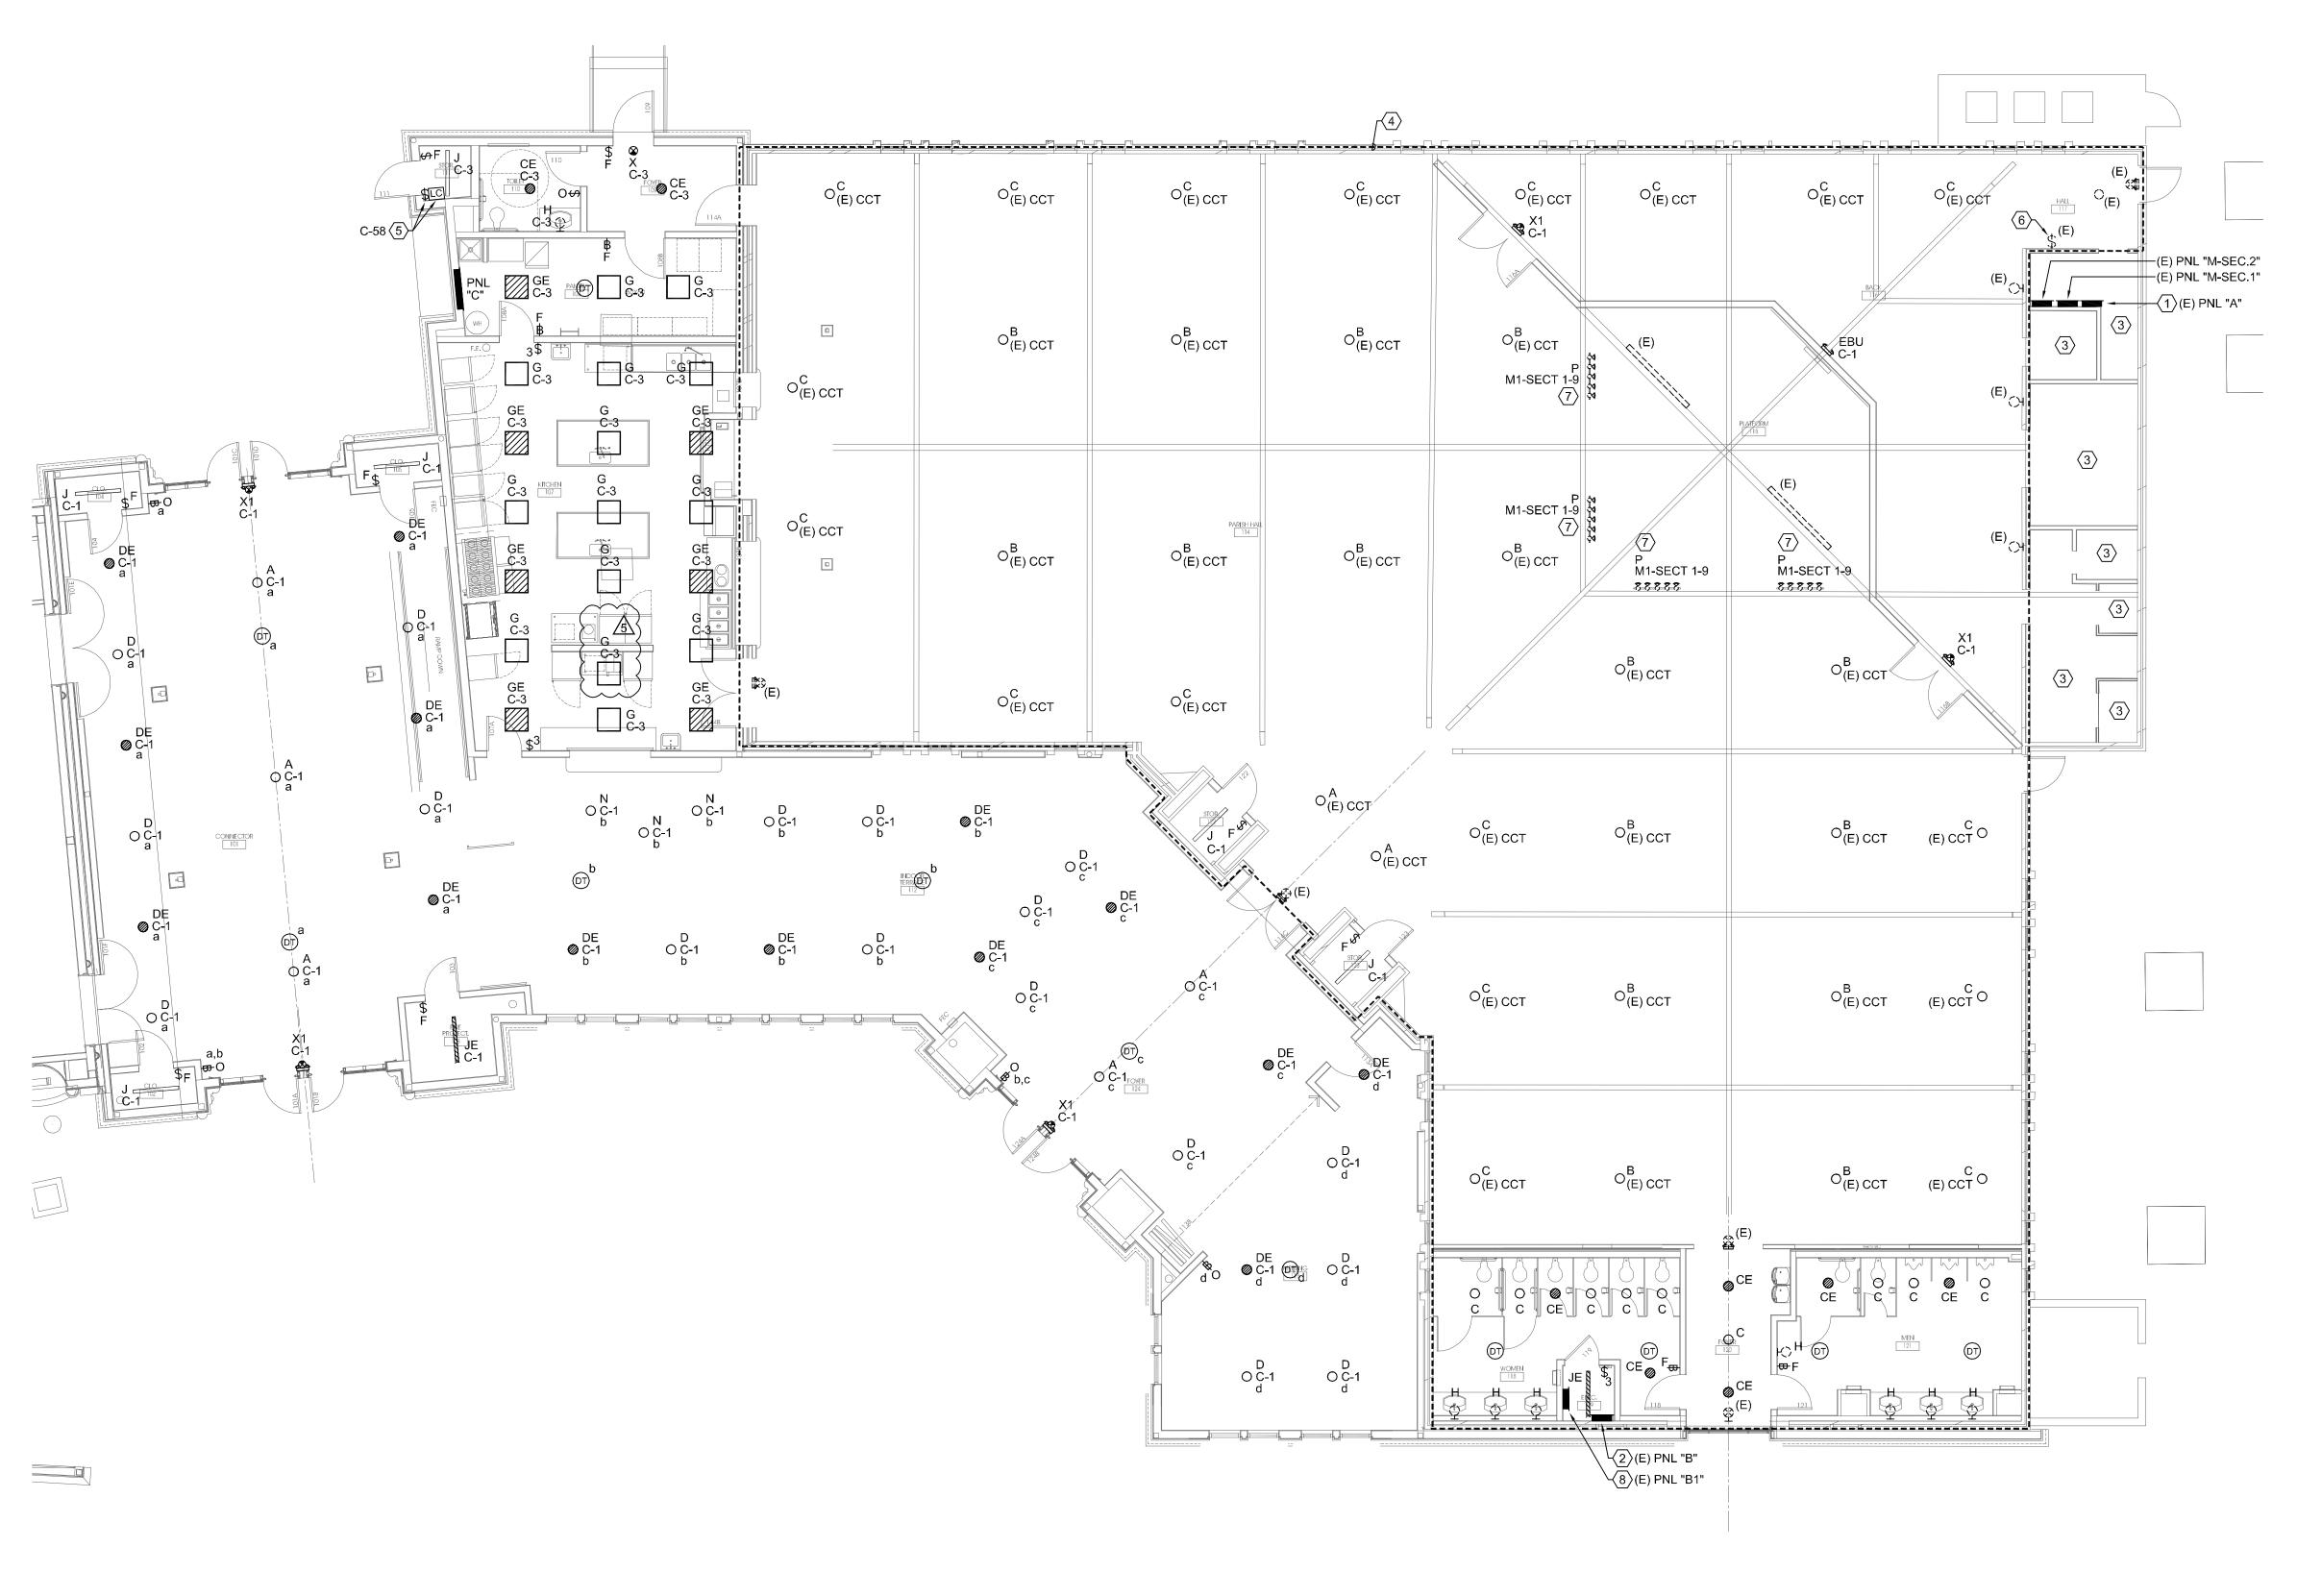
> ST. JUDE CATHOLIC CHURCH

PARISH HALL REMODEL & CONNECTOR

500 E DALLAS ST. MANSFIELD, TX 76063

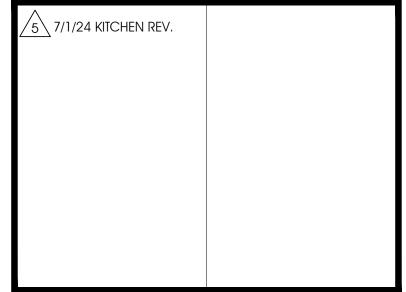

| Drawing Title: | |
|----------------|---|
| REFLECTED (| CEILING PLAN |
| | |
| Project No. | Date: |
| 2307 | 1/12/2024 |
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| FERED APON | Sheet No. |
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GENERAL NOTES

- RE: E0.1 FOR ELECTRICAL SYMBOLS, ADDITIONAL GENERAL NOTES, AND ABBREVIATIONS.
- RE: E0.2 FOR ELECTRICAL SPECIFICATIONS.
- RE: E0.3 FOR LIGHTING CONTROL DETAILS
- RE: E5.1 FOR BRANCH WIRING SCHEDULE FOR WIRE
- RE: E6.1 OR PANELBOARD SCHEDULES.
- RE: E6.2 FOR LIGHT FIXTURE SCHEDULE.
- RE: E6.2 FOR MECHANICAL / ELECTRICAL SCHEDULE.
- LIGHTING CONTROLS TO INCLUDE "DAYLIGHTING ZONE" REQUIREMENTS.
- PROVIDE ADDITIONAL CONDUCTOR WITHIN CIRCUITS WHERE REQUIRED FOR FOR UNSWITCHED POWER TO EXIT SIGNS AND EMERGENCY BALLAST / DRIVER
- DESIGNATION REPRESENTS:
- (E) EXISTING ELECTRICAL DEVICE TO REMAIN AS IS. (R) EXISTING ELECTRICAL DEVICE TO TO BE REMOVED IN ITS ENTIRETY.
- (RR) REMOVE AND RELOCATED EXISTING ELECTRICAL
- (NL) NEW LOCATION FOR EXISTING RELOCATED

RE-USED FOR NEW LIGHT FIXTURES.

ELECTRICAL DEVICE. CCT EXISTING LIGHTING BRANCH CIRCUITING TO BE

NOTES BY SYMBOL " #)"

- EXISTING PANEL IS NOT LABELED. FOR DRAWING PURPOSES THIS EXISTING PANEL WILL BE IDENTIFIED
- (2) EXISTING PANEL IS NOT LABELED. FOR DRAWING PURPOSES THIS EXISTING PANEL WILL BE IDENTIFIED
- NO ELECTRICAL WORK REQUIRED IN THIS ROOM. MAINTAIN LIGHTING AND POWER BRANCHING CIRCUITING CONTINUITY. EXISTING SWITCH TO REMAIN AS IS AND MAINTAIN SWITCHING CONFIGURATION. UNLESS NOTED OTHERWISE
- RE-USE EXISTING LIGHTING BRANCH CIRCUITING TO RE-CONNECT TO NEW LIGHT FIXTURE(S) INDICATED.
- (5) EXTERIOR LIGHTING CONTACTOR AND BY-PASS SWITCH. RE: 1/E0.3 EXTERIOR LIGHTING CONTACTOR WIRING DIAGRAM FOR ADDITIONAL INFORMATION.
- (6) EXISTING LIGHT SWITCHES (TOTAL OF 27) ARE TO REMAIN AS IS. MAINTAIN CIRCUITING CONTINUITY AND SWITCHING CONFIGURATION.
- (7) NEW TRACK LIGHTING. PROVIDE A NEW LIGHTING CIRCUIT AS INDICATED. ROUTE CONDUIT BACK TO EXISTING PANELBOARD "M1-SECT-1" AND EXISTING BANK OF SWITCHES. PROVIDE DIMMER 400 WATT DIMMERS, PAINT EXPOSED CONDUIT TO MATCH WOOD CEILING. COORDINATE COLOR WITH THE ARCHITECTS PRIOR TO PAINTING.

MEP Consultant

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PARISH HALL REMODEL & CONNECTOR

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<u>√5</u> 07/01/2024 KITCHEN REV.

PERMIT SET

Drawing Title: PARTIAL FLOOR -LIGHTING PLAN

Project No. 2307


1/12/2024

Date:

Sheet No.

PARTIAL FLOOR - LIGHTING PLAN

Scale: 1/8" = 1'-0"

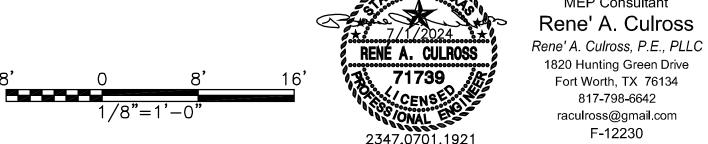

GENERAL NOTES APPLY TO ALL: VERIFY MOUNTING REQUIREMENTS WITH EQUIPMENT INSTALLER.

VERIFY MOUNTING REQUIREMENTS WITH EQUIPMENT INSTALLER.


VERIFY ACTUAL EQUIPMENT LOADS AND CONNECTION REQUIREMENTS WITH EQUIPMENT BEING INSTALLED.

NOTES:

1. COORDINATE ALL EQUIPMENT REQUIREMENTS AND LOCATION WITH THE ARCHITECTS / KITCHEN CONSULTANTS DRAWINGS PRIOR TO INSTALLATION.
2. PIECE OF EQUIPMENT IS LOCATED UNDER THE KITCHEN HOOD. PROVIDE A SHUNT TRIP CIRCUIT BREAKER. CIRCUIT NUMBER IN THE (#) PARENTHESIS REPRESENT CIRCUIT BREAKER.
3. LOCATE THE RECEPTACLE WITHIN THE CABINET. COORDINATE EXACT LOCATION WITH THE ARCHITECT PRIOR TO INSTALLATION.


GENERAL NOTES

- RE: E0.1 FOR ELECTRICAL SYMBOLS, ADDITIONAL GENERAL NOTES, AND ABBREVIATIONS.
- RE: E0.2 FOR ELECTRICAL SPECIFICATIONS.
- RE: E0.3 FOR LIGHTING CONTROL DETAILS
- 4. RE: E5.1 FOR BRANCH WIRING SCHEDULE FOR WIRE
- RE: E6.1 OR PANELBOARD SCHEDULES.
- 6. RE: E7.1 FOR LIGHT FIXTURE SCHEDULE.
- 7. RE: E7.1 FOR MECHANICAL / ELECTRICAL SCHEDULE.
- 3. LIGHTING CONTROLS TO INCLUDE "DAYLIGHTING ZONE" REQUIREMENTS.
- 9. PROVIDE ADDITIONAL CONDUCTOR WITHIN CIRCUITS WHERE REQUIRED FOR FOR UNSWITCHED POWER TO EXIT SIGNS AND EMERGENCY BALLAST / DRIVER SYSTEMS.
- 10. DESIGNATION REPRESENTS:
- (X) EXISTING ELECTRICAL DEVICE TO REMAIN AS IS.
 (R) EXISTING ELECTRICAL DEVICE TO TO BE REMOVED IN ITS ENTIRETY.
- (RR) REMOVE AND RELOCATED EXISTING ELECTRICAL
- (NL) NEW LOCATION FOR EXISTING RELOCATED ELECTRICAL DEVICE.
- CCT EXISTING LIGHTING BRANCH CIRCUITING TO BE RE-USED FOR NEW LIGHT FIXTURES.

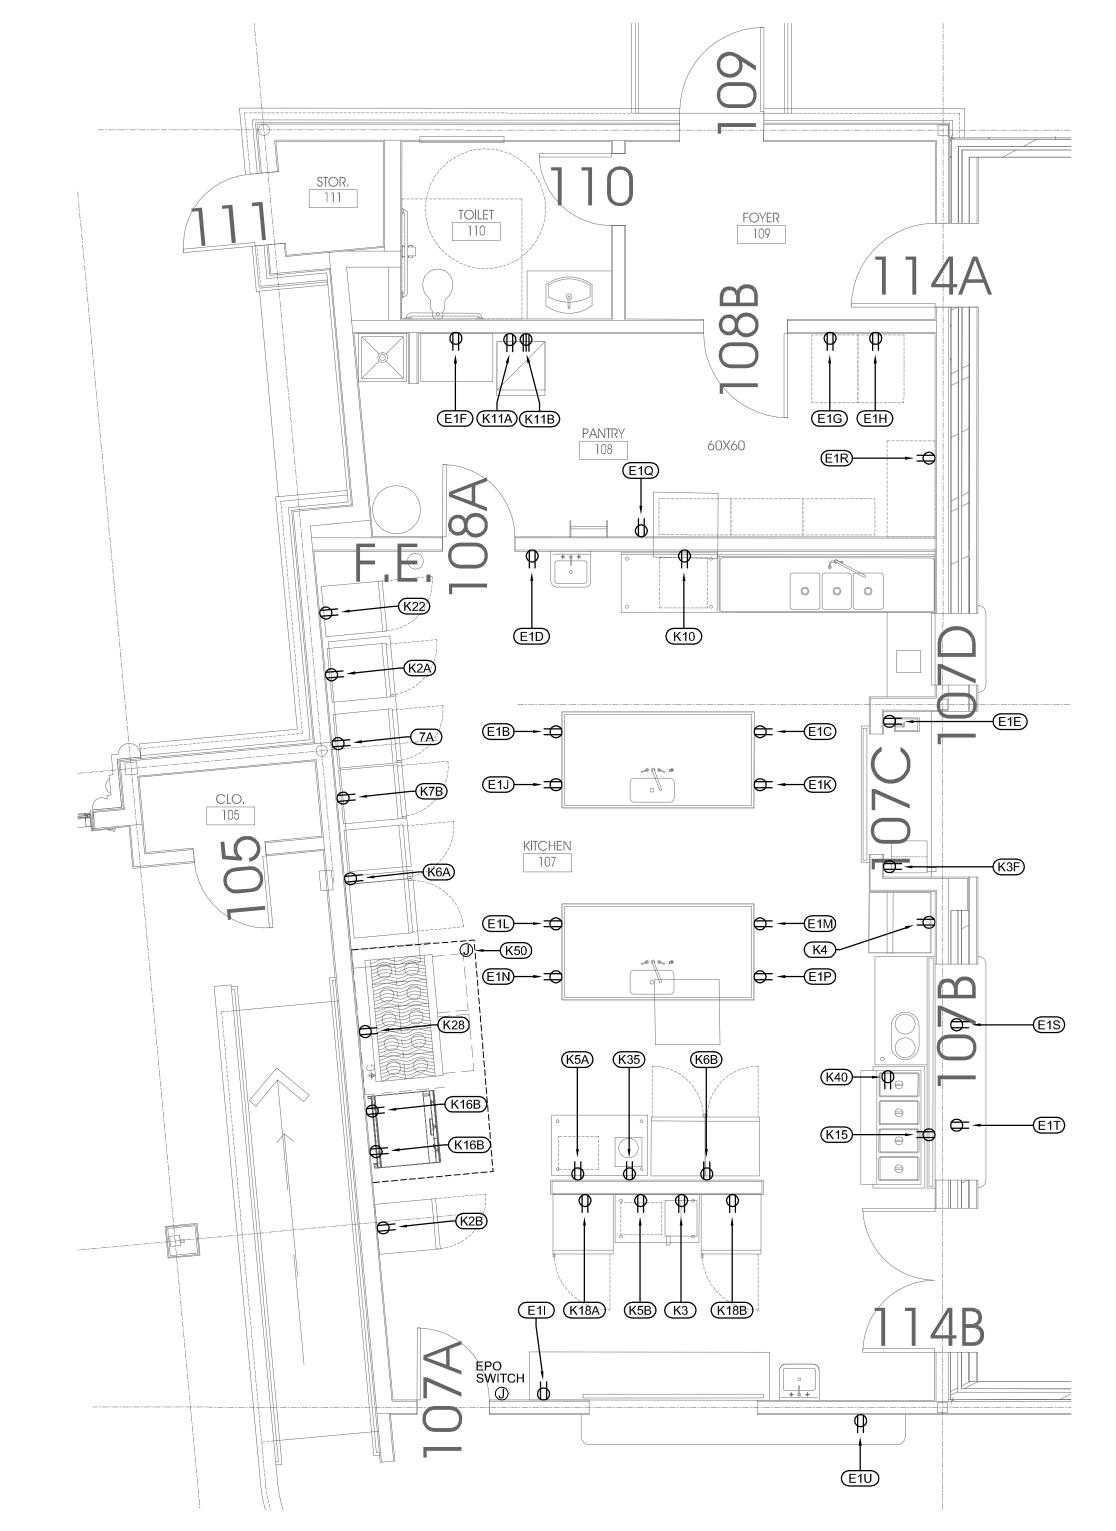



PARTIAL FLOOR - ENLARGED KITCHEN - POWER PLAN

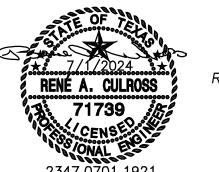

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ST. JUDE
CATHOLIC
CHURCH
PARISH HALL
REMODEL &

500 E DALLAS ST. MANSFIELD, TX 76063

CONNECTOR

5 07/01/2024 KITCHEN REV.

PERMIT SET

Drawing Title:

PARTIAL FLOOR - ENLARGED

KITCHEN - POWER PLAN

Project No. Date:

Project No.

2307 1/12/2024

Sheet No.

E4.1

| PANEL "C" CC DEVICE TYPE: BREAKER DEVICE FAMILY: BOLT ON FED FROM: UTILITY | | | | | | | | • |): 400 MCB 3-PHASE 4-WIRE | CONTINUOUS(A): BUS SC RATING(A FAULT CURRENT(| • | | | |
|---|--------------|---------------------------|----------------|-------|--------|------------|-----------|------------|------------------------------|---|----------------|-----------------------|--------------------|--------------|
| OC MPS P | NOTES | DESCRIPTION | DEMAND CODE | VA | СКТ | PHASE A | LOAI B | DS VA C | СКТ | VA | DEMAND CODE | DESCRIPTION | NOTES | OC AMPS P |
| 20 1 | _ | INTERIOR LIGHTING | LTG | 1077 | 1 | 2914 | | | 2 | 1837 | REC | KITCHEN EQUIPMENT - | - K2A - | 20 1 |
| 20 1 | - | INTERIOR LIGHTING | LTG | 750 | 3 | | 2577 | | 4 | 1827 | REC | KITCHEN EQUIPMENT - | - K2B - | 20 1 |
| 20 1 | - | INTERIOR RECEPTALCES | REC | 900 | 5 | | | 2424 | 6 | 1524 | REC | KITCHEN EQUIPMENT - | - K3 - | 20 1 |
| 20 1 | - | INTERIOR RECEPTACLES | REC | 360 | 7 | 2160 | | | 8 | 1800 | REC | KITCHEN EQUIPMENT - | - K4 _ | 20 1 |
| 30 2 | - | KITCHEN EQUIPMENT - K10 | REC | 5034 | 9 | | 4125 | | 10 | 1608 | REC | KITCHEN EQUIPMENT - | - K5A _ | 20 1 |
| _ | - | - | _ | - | 11 | | | 3165 | 12 | 648 | REC | KITCHEN EQUIPMENT - | - K6A _ | 20 1 |
| 20 1 | - | KITCHEN EQUIPMENT - K11A | REC | 1440 | 13 | 2088 | | | 14 | 648 | REC | KITCHEN EQUIPMENT - | - K6B _ | 20 1 |
| 30 2 | - | KITCHEN EQUIPMENT - K11B | REC | 4992 | 15 | | 3648 | | 16 | 1152 | REC | KITCHEN EQUIPMENT - | - K7A - | 20 1 |
| - | - | _ | _ | _ | 17 | | | 3648 | 18 | 1152 | REC | KITCHEN EQUIPMENT - | - K7B - | 20 1 |
| 20 1 | - | KITCHEN EQUIPMENT - K50 | REC | 1080 | 19 | 2080 | | | 20 | 1000 | REC | KITCHEN EQUIPMENT - | - K17 - | 20 1 |
| 20 1 | - | KITCHEN EQUIPMENT - E1A | REC | 1200 | 21 | | 1546 | | 22 | 346 | REC | KITCHEN EQUIPMENT - | - K18A - | 15 1 |
| 20 1 | _ | KITCHEN EQUIPMENT - E1B | REC | 1200 | 23 | | | 2700 | 24 | 1500 | REC | KITCHEN EQUIPMENT - | - K15 - | 20 1 |
| 20 1 | - | KITCHEN EQUIPMENT - E1C | REC | 1200 | 25 | 4032 | | | 26 | 8496 | COOL | RTU-PH-1 | _ | 40 3 |
| 20 1 | - | KITCHEN EQUIPMENT - E1D | REC | 1200 | 27 | | 4032 | | 28 | _ | _ | - | - | - |
| 60 2 | = | RTU-PH-2 | COOL | 14112 | 29 | | | 7536 | 30 | _ | = | - | _ | _ |
| _ | _ | - | _ | _ | 31 | 7536 | | | 32 | 11232 | COOL | RTU-PH-3 | _ | 50 3 |
| _ | - | _ | _ | _ | 33 | | 7536 | | 34 | _ | = | _ | _ | _ |
| 50 3 | _ | RTU-PH-4 | COOL | 11232 | 35 | | | 7488 | 36 | _ | = | _ | - | _ |
| - | _ | _ | _ | - | 37 | 4176 | | | 38 | 1260 | GEN | KEF-PH-1 | _ | 20 2 |
| - | _ | _ | _ | _ | 39 | | 4176 | | 40 | - | = | _ | _ | _ |
| 20 1 | - | IWH-HP-1 | GEN | 87 | 41 | | | 3831 | 42 | _ | = | - | _ | _ |
| 20 1 | = | KSF-PH-1 | MTR | 600 | 43 | 2100 | | | 44 | 3000 | GEN | UH-PH-1 | _ | 20 2 |
| 20 1 | - | FLOOR RECEPTACLE | REC | 1200 | 45 | | 2700 | | 46 | _ | = | _ | _ | - |
| 20 1 | - | FLOOR RECEPTACLE | REC | 1200 | 47 | | | 2200 | 48 | 1000 | REC | KITCHEN EQUIPMENT - | - E1E - | 20 1 |
| 20 1 | - | INTERIOR RECEPTACLE | REC | 1200 | 49 | 2200 | | | 50 | 1000 | REC | KITCHEN EQUIPMENT - | - E1F _ | 20 1 |
| 20 1 | - | INTERIOR RECEPTACLE | REC | 1200 | 51 | | 2200 | | 52 | 1000 | REC | KITCHEN EQUIPMENT - | - E1G _ | 20 1 |
| 20 1 | - | INTERIOR RECEPTACLE | REC | 1200 | 53 | | | 2200 | 54 | 1000 | REC | KITCHEN EQUIPMENT | - E1H _ | 20 1 |
| 20 1 | - | EXTERIOR RECEPTACLE | REC | 180 | 55 | 1180 | | | 56 | 1000 | REC | KITCHEN EQUIPMENT - | - E1I _ | 20 1 |
| 20 1 | - | EXTERIOR RECEPRACLE | REC | 180 | 57 | | 680 | | 58 | 500 | LTG | EXTERIOR LTG CONTA | CTOR - | 20 1 |
| 20 1 | - | EXTERIOR RECEPTACLES | REC | 360 | 59 | | | 860 | 60 | 500 | LTG | EXTERIOR LIGHTING | - | 20 1 |
| 20 1 | - | EXTERIOR RECEPTACLE | REC | 180 | 61 | 1380 | | | 62 | 1200 | REC | KITCHEN EQUIP - E1J 8 | kE1K - | 20 1 |
| 20 1 | = | KITCHEN EQUIP - E1S & E1T | REC | 1200 | 63 | | 2400 | | 64 | 1200 | REC | KITCHEN EQUIP - E1L 8 | & E1M - | 20 1 |
| 20 1 | - | KITCHEN EQUIPMENT E1U | REC | 1200 | 65 | | | 2400 | 66 | 1200 | REC | KITCHEN EQUIP - E1N | & E1P - | 20 1 |
| 20 1 | - | KITCHEN EQUIPMENT - K5B | REC | 1200 | 67 | 2400 | | | 68 | 1200 | REC | KITCHEN EQUIP - E1Q | & E1R - | 20 1 |
| 15 1 | - | KITCHEN EQUIPMENT - K18B | REC | 346 | 69 | | 546 | | 70 | 200 | REC | KITCHEN EQUIPMENT - | - K28 - | 20 1 |
| 20 1 | - | KITCHEN EQUIPMENT - K16A | REC | 1200 | 71 | | | 1200 | 72 | 0 | - | SHUNT TRIP CB - K28 | - | 20 1 |
| 20 1 | - | SHUNT TRIP CB - K16A | - | - | 73 | 1200 | | | 74 | 1200 | REC | KITCHEN EQUIPMENT - | - K35 - | 20 1 |
| 20 1 | - | KITCHEN EQUIPMENT - K16B | REC | 1200 | 75 | | 2400 | | 76 | 1200 | REC | KITCHEN EQUIPMENT - | - K40 – | 20 1 |
| 20 1 | - | SHUNT TRIP CB - K16B | - | - | 77 | | | 0 | 78 | 0 | SPR | SPARE | - | 20 1 |
| 20 1 | - | KITCHEN EQUIPMENT - K3F | REC | 1200 | 79 | 1200 | | | 80 | 0 | SPR | SPARE | - | 20 1 |
| 20 1 | _ | SPARE | SPR | 0 | 81 | | 0 | | 82 | 0 | SPR | SPARE | - | 20 1 |
| 20 1 | = | SPARE | SPR | 0 | 83 | | | 0 | 84 | 0 | SPR | SPARE | - | 20 1 |
| ALL C | CONNECTED | KVA MAX AMPS | ' | * PH | SE TOT | ALS | VA | | AMP | S | | | BUS TOTALS | KVA |
| | L CONNECTED | 94.83 263.4 | | * A-N | | | 36746 | | 306. | | | | | 108.62 |
| | L DEMAND | 94.83 263.4 | | * B-N | | | 39766 | | 331. | | | | DEMAND (125% LTG) | 3.53 |
| | L DESIGN | 94.83 263.4 | | * C-N | | | 39742 | | 331. | | | | DEMAND (100% HVAC) | 47.12 |
| | | | | | | | | | | | | | DEMAND (65% KIT) | 44.18 |
| | | | | | | | | | | | | | DEMAND | 94.83 |
| | | | | | | | | | | | | | DESIGN | 94.83 |
| NOTE | -0 | | | | | | | | | | | | | |

PANELBOARD NOTES ONLY

- 1. EXISTING CIRCUIT BREAKER AND LOAD(S) TO REMAIN AS IS.
- 2. DISCONNECT AND REMOVE EXISTING "BLANK" FILLER TO ALLOW NEW CIRCUIT BREAKER AS INDICATED.
- PROVIDE A NEW CIRCUIT BREAKER AS INDICATED. MATCH EXISTING MANUFACTURER AND AIC RATING.
- 4. PROVIDE AN UPDATE PANELBOARD SCHEDULE.

| | | LIGHT FI | XTURE SCH | EDULE | | | | |
|------|--|--|----------------------|------------------------------|------------------|----------------------------------|-----------|-------|
| MARK | TYPE OF LUMINAIRE | MANUFACTURE / CATALOG NUMBER | QTY-TYPE OF LAMP | MAXIMUM INPUT WATTS | INPUT VOLTAGE | ALLOCATED FIXTURE LOAD(VA) | MOUNTING | NOTE |
| А | LED PENDANT LIGHT | WAC LIGHTING # PD-42918-BK | LED (2400 LUMENS) | 41 | 120 | 41 | PENDANT | 1 |
| В | LED PENDANT LIGHT | WAC LIGHTING # PD-72718-BK | LED (2450 LUMENS) | 33.5 | 120 | 33.5 | PENDANT | 1 |
| С | 6" APERATURE DOWNLIGHT | LITHONIA LIGHTING # LDN6 30 20 L06 AR LSS 120 | LED | 26 | 120 | 26 | RECESSED | 1 |
| CE | 6" APERATURE DOWNLIGHT | LITHONIA LIGHTING # LDN6 30 20 L06 AR LSS 120 EL | LED | 26 | 120 | 26 | RECESSED | 1,2 |
| D | 6" APERATURE DOWNLIGHT | LITHONIA LIGHTING # LDN6 30 20 L06 AR LSS 120 | LED | 26 | 120 | 26 | RECESSED | 1 |
| DE | 6" APERATURE DOWNLIGHT | LITHONIA LIGHTING # LDN6 30 20 L06 AR LSS 120 EL | LED | 26 | 120 | 26 | RECESSED | 1,2 |
| G | 2 x 2 FLAT PANEL LIGHT | LITHONIA LIGHTING # EPANL2X2 3400LM 80CRI 35K ZT 120 | LED | 31 | 120 | 31 | RECESSED | 1 |
| GE | 2 x 2 FLAT PANEL LIGHT | LITHONIA LIGHTING # EPANL2X2 3400LM 80CRI 35K E10WCP ZT 120 | LED | 31 | 120 | 31 | RECESSED | 1,2 |
| Н | VANITY LIGHT | WAC LIGHTING # WS-77624-35-BK | LED | 20.5 | 120 | 20.5 | WALL | 1 |
| J | 4'-0" LED STRIPLIGHT | LITHONIA LIGHTING # ZLIN L48 ASR 3000LM ASR 120 30K 80 CRI WH HC36M12 | LED | 25 | 120 | 25 | SUSPENDED | 1 |
| JE | 4'-0" LED STRIPLIGHT | LITHONIA LIGHTING # ZLIN L48 ASR 3000LM ASR 120 30K 80 CRI E10WLCP WH HC36M12 | LED | 25 | 120 | 25 | SUSPENDED | 1,2 |
| К | WALL PACK | PAC LIGHTS # FWPR/2-025-30 | LED | 25 | 120 | 25 | WALL | 1 |
| L | LIGHT BLOLLARD | MATCH EXISTING BOLLARDS | LED | 20 | 120 | 20 | GRADE | 1 |
| М | ACCENT LIGHT | LITHONIA LIGHTING # DSXF1-LED-P1-WFL-MVOLT-THK | LED | 21 | 120 | 21 | GRADE | 1 |
| N | 6" APERATURE DOWNLIGHT WITH GLASS LENS | CALIBER PLUS # SERIES 5LBVG W/GDW DECO GLASS LENS | LED | 26 | 120 | 26 | RECESSED | 1 |
| Р | 4'-0" TRACK | JUNO TRACK # R4BL TRAC-MASTER LIMITER SWITCH # TCLF11BL TRACK HEAD # T259L G2 35K 80CRI PDIM BL | LED | 60W PER HEAD (5 TOTAL) | 120 | 300 | SURFACE | 1,3,4 |
| (RR) | EXISTING LIGHT FIXTURE | EXISTING RELOCATED LIGHT FIXTURE | - | - | 120 | - | GRADE | 1 |
| (NL) | EXISTING RELOCATED LIGHT FIXTURE | EXISTING RELOCATED LIGHT FIXTURE | - | - | 120 | - | GRADE | 1 |
| X1 | EXIT SIGN W/EMERGENCY BUG-EYES | LITHONIA LIGHTING # LHQM LED R M6 | LED | 4.3 | 120 | 4.3 | UNIVERSAL | 1 |
| EBU | EMERGENCY BATTERY UNIT | COOPER LIGHTING SURE-LITE # AEL2-31-BK | LED | 2.2 | 120 | 2.2 | WALL | 1 |

- GENERAL NOTES:

 1. PROVIDE ALL REQUIRED MOUNTING HARDWARE AND TRIM.

 2. RE: 1/E0.3 EMERGENCY BALLAST/DRIVER SWITCHING DETAIL FOR ADDITIONAL INFORMATION,
- PROVIDE A 300 WATT LIMITER SWITCH. ONE (1) PER TRACK. 4. COORDINATE EXACT LOCATION WITH THE ARCHITECT RCP PLAN PRIOR TO INSTALLATION.

| | MEC | HANICA | L EQ | UIPN | IENT / | ELE | ECTRIC | AL SCHEDU | LE BY SYMB | OL "#" | • | |
|-----------|------------------------------|-----------------|------|------|----------|--------------------|----------|-----------------|------------------|---|-----------------------|-------|
| NO | DECODIDATION | LIMIT CEDVEC | | LOAD | | DISCONNECT AT UNIT | | CIRCUIT | | 1,,,,,,,,,,,,,,,,,,,,,,,,,,,,,,,,,,,,,, | | |
| NO. | DESCRIPTION | UNIT SERVES | MCA | МОСР | kW OR HP | FLA | VOLTS/PH | TYPE | MOUNTING | NUMBER | WIRE SIZE | NOTES |
| RTU-PH-1) | ROOF TOP UNIT - PH - 1 | KITCHEN AREA | 29.5 | 40A | - | - | 208 / 3 | BY DIVISION 23 | BY DIVISION 23 | C-26,28,30 | 1"C - 3#8, 1#10G | 1 |
| RTU-PH-2) | ROOF TOP UNIT - PH - 2 | EXIST. FACILITY | 49.0 | 60A | - | - | 208 / 3 | BY DIVISION 23 | BY DIVISION 23 | C-29,31,33 | 1-1/4"C - 3#4, 1#10G | 1 |
| RTU-PH-3 | ROOF TOP UNIT - PH - 3 | CONNECTOR | 39.0 | 50A | - | - | 208 / 3 | BY DIVISION 23 | BY DIVISION 23 | C-32,34,36 | 1"C - 3#6, 1#10G | 1 |
| RTU-PH-4) | ROOF TOP UNIT - PH - 4 | CONNECTOR | 39.0 | 50A | - | - | 208 / 3 | BY DIVISION 23 | BY DIVISION 23 | C-35,37,39 | 1"C - 3#6, 1#10G | 1 |
| UH-PH-1 | UNIT HEATER - PH - 1 | RISER ROOM | 14.5 | 20A | - | - | 208 / 1 | 30A/NF/NEMA 1 | ADJACENT TO UNIT | C-44,46 | 3/4"C - 3#12, 1#12G | 1 |
| EF-PH-1 | EXHAUST FAN - PH - 1 | EXIST TOILETS | - | 20A | 0.3 HP | - | 120 / 1 | BY DIVISION 23 | BY DIVISION 23 | B1-5 | 3/4"C - 2#12, 1#12G | 1 |
| EF-PH-2 | EXHAUST FAN - PH - 2 | TOILETS | - | 20A | 85W | - | 120 / 1 | BY DIVISION 23 | BY DIVISION 23 | C-3 | 3/4"C - 2#12, 1#12G | 1 |
| EF-PH-3 | EXHAUST FAN - PH - 3 | CRAWL SPACE | - | 20A | 0.17 HP | - | 120 / 1 | BY DIVISION 23 | BY DIVISION 23 | B1-5 | 3/4"C - 2#12, 1#12G | 1 |
| EF-PH-4 | EXHAUST FAN - PH - 4 | CRAWL SPACE | _ | 20A | 0.17 HP | - | 120 / 1 | BY DIVISION 23 | BY DIVISION 23 | B1-5 | 3/4"C - 2#12, 1#12G | 1 |
| KEF-PH-1 | KITCHEN EXHAUST FAN - PH - 1 | KITCHEN HOOD | - | 20A | 0.75 HP | - | 208 / 3 | BY DIVISION 23 | BY DIVISION 23 | C-38,40,42 | 3/4"C - 3#12, 1#12G | 1 |
| KSF-PH-1) | KITCHEN SUPPLY FAN - PH - 1 | KITCHEN HOOD | - | 20A | 0.33 HP | - | 120 / 1 | BY DIVISION 23 | BY DIVISION 23 | C-43 | 3/4"C - 2#12, 1#12G | 1 |
| (IWH-1) | INSTANTANEOUS WATER HTR - 1 | _ | - | 20A | 3 KW | <u>-</u> | 208 / 1 | 5 LOCKABLE C.B. | IN PANELBOARD | B1-6.8 | 3/4"C - 2#12, 1#12G | 1 |
| (IWH-2) | INSTANTANEOUS WATER HTR - 2 | - | - | 20A | 3 KW | - | 208 / 1 | LOCKABLE C.B. | IN PANELBOARD | B1-2,4 |) 3/4"C - 2#12, 1#12G | 1 |
| WH-PH-1) | WATER HEATER - HP - 1 | - | = | 20A | \$ 87W | - | 120 / 1 | BY DIVISION 23 | BY DIVISION 23 | C-41 | 3/4"C - 2#12, 1#12G | 1 |

VERIFY MOUNTING REQUIREMENTS WITH EQUIPMENT INSTALLER. VERIFY ACTUAL EQUIPMENT LOADS AND CONNECTION REQUIREMENTS WITH EQUIPMENT BEING INSTALLED.

1. WIRE SIZED IS BASED ON NEC 310.16 75 DEGREE WIRE AND COPPER.



MEP Consultant Rene' A. Culross Rene' A. Culross, P.E., PLLC 1820 Hunting Green Drive Fort Worth, TX 76134 817-798-6642 raculross@gmail.com F-12230

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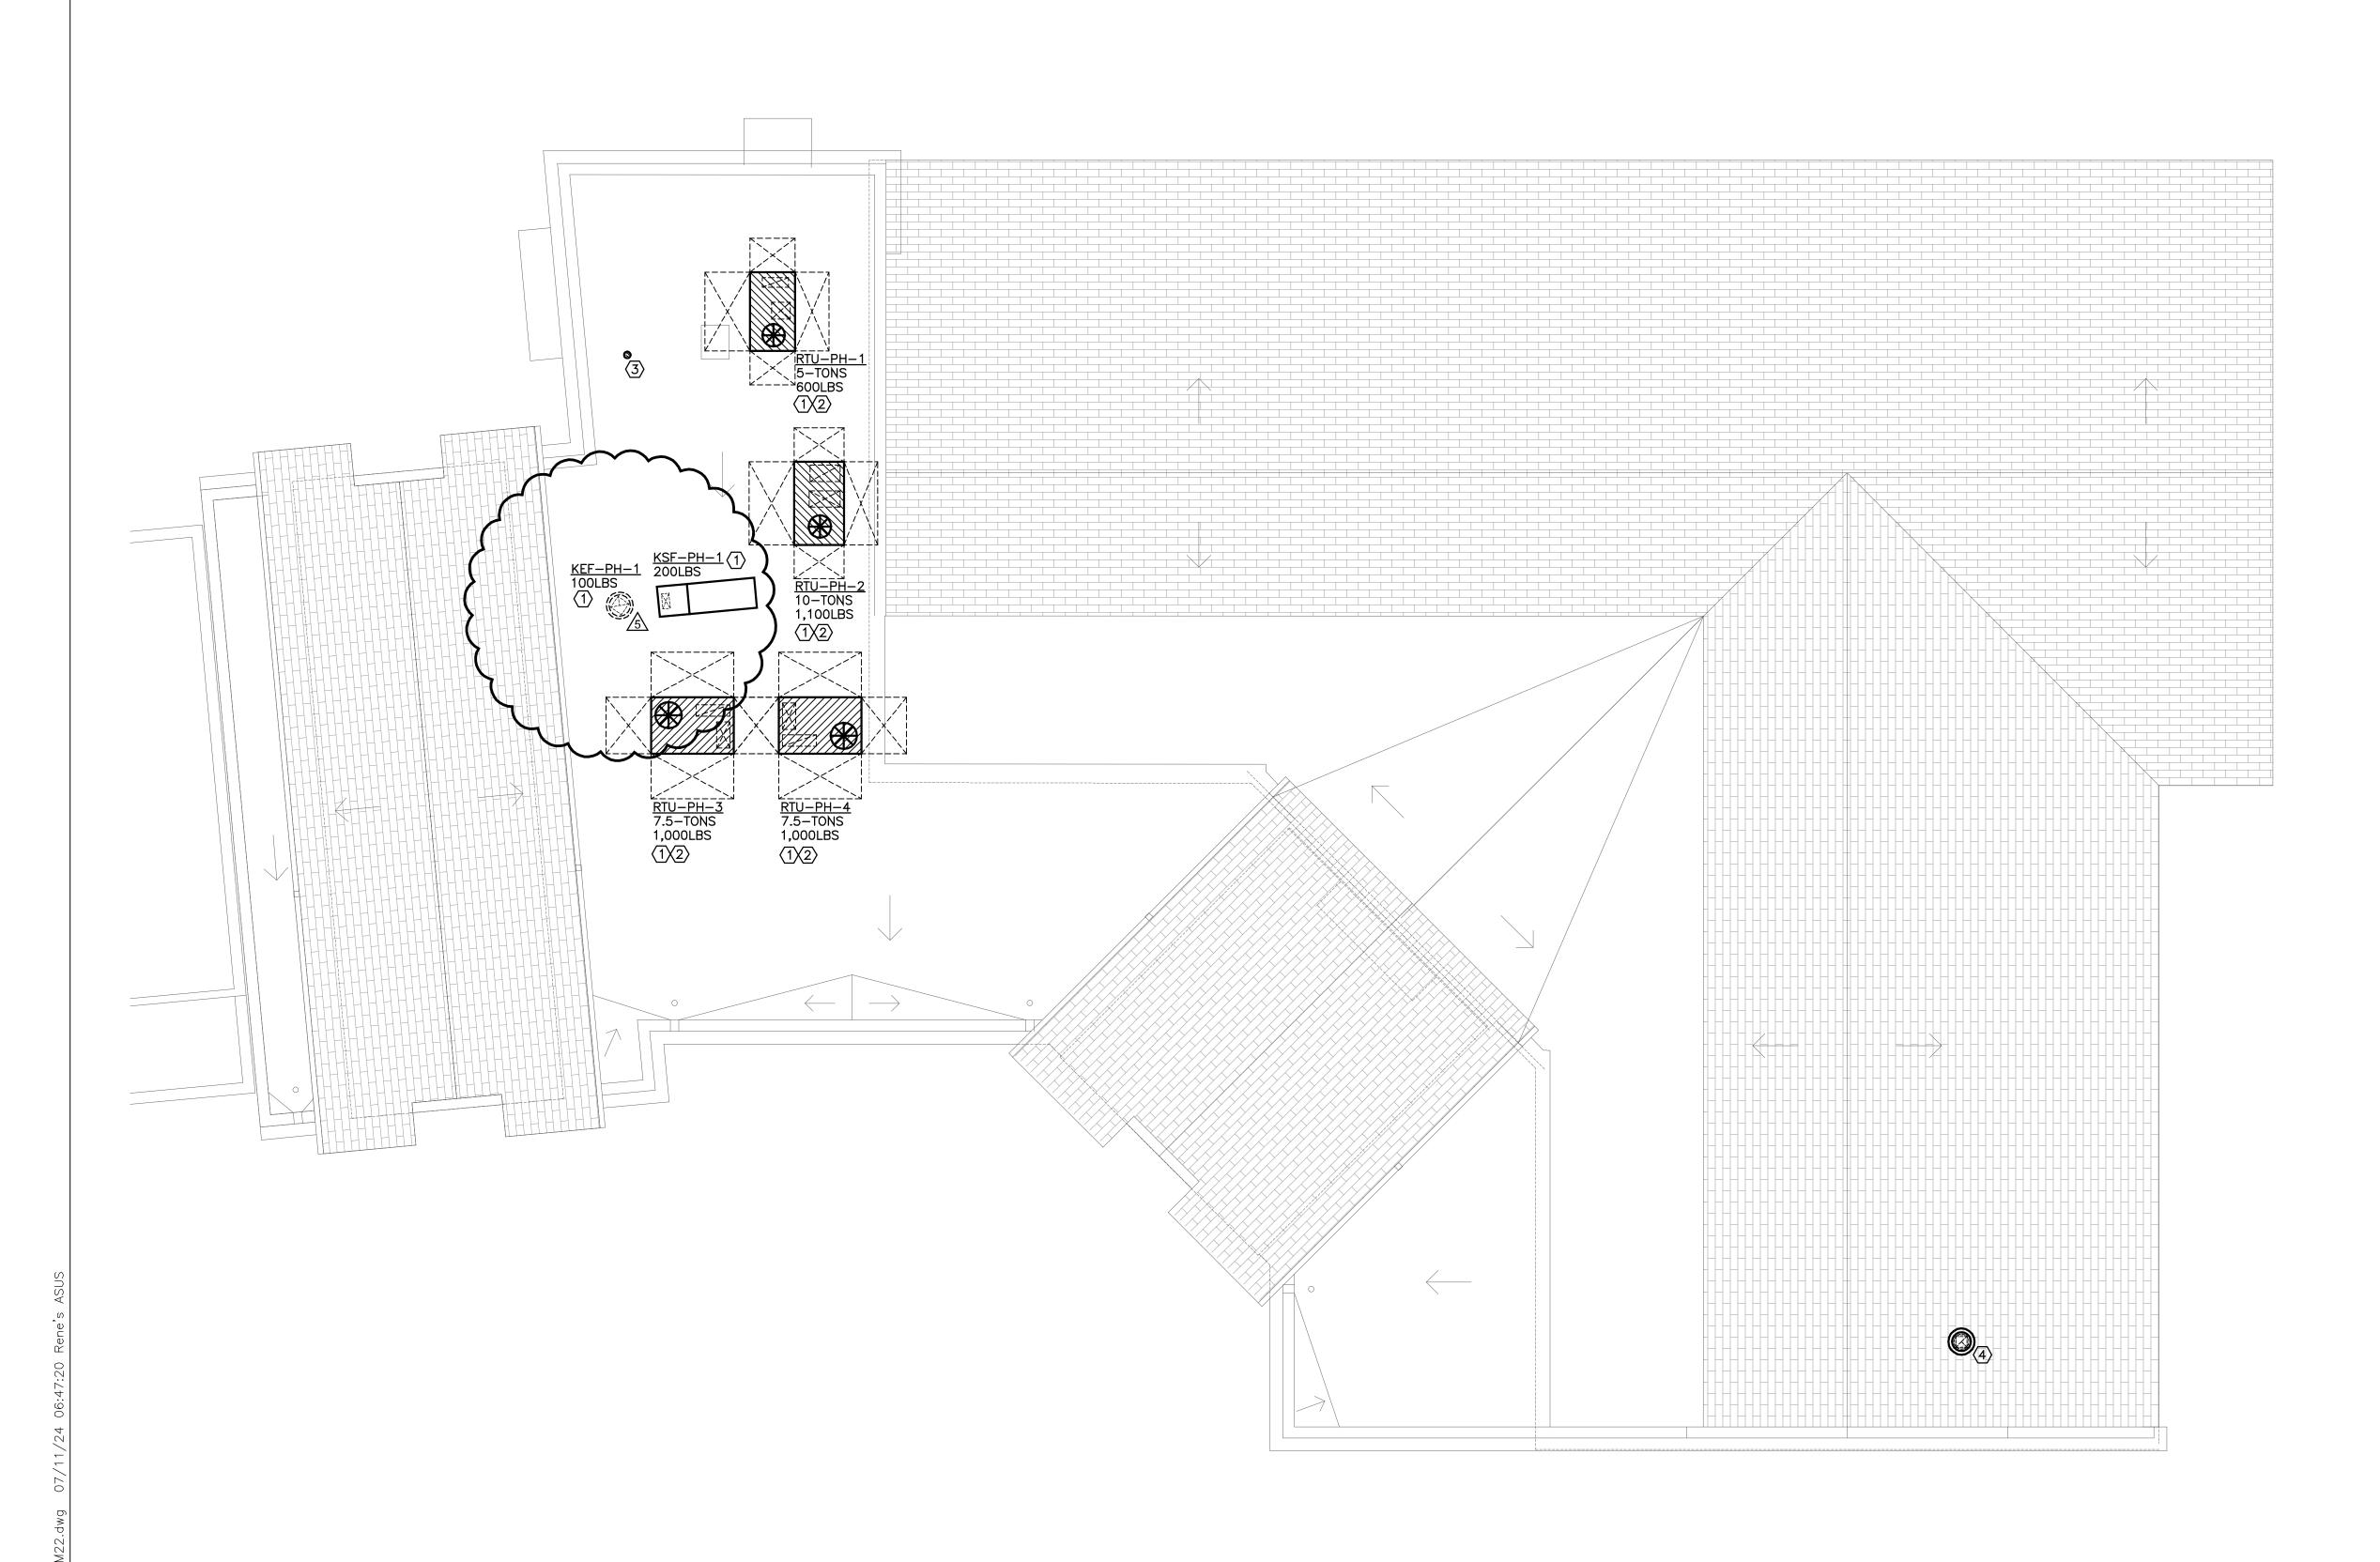
ST. JUDE CATHOLIC CHURCH PARISH HALL REMODEL &


500 E DALLAS ST. MANSFIELD, TX 76063

CONNECTOR

| 5 07/01/2024 KITCHEN REV. | | |
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| Drawing Title: | | | | | | |
|---|-----------|--|--|--|--|--|
| PANELBOARD & LIGHT FIXTURE SCHEDULES | | | | | | |
| Project No. | Date: | | | | | |
| 2307 | 1/12/2024 | | | | | |
| | Sheet No. | | | | | |
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PARTIAL ROOF - HVAC PLAN


Scale: 1/8" = 1'-0"

NOTES BY SYMBOL "T"

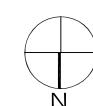- TRANSITION TO/FROM FULL—SIZE EQUIPMENT OPENING FROM/TO SIZE SHOWN ON PLAN AT ROOF DECK. REFER TO M3.1 FOR ADDITIONAL INSTRUCTIONS.
- (2) MAINTAIN MANUFACTURER'S RECOMMENDED SERVICE AND AIR FLOW CLEARANCES.
- (3) CONCENTRIC VENT THROUGH ROOF. REFER TO DETAIL 8/M4.1 FOR ADDITIONAL INSTRUCTIONS.
- EXHAUST HOOD EQUAL TO LOREN COOK PR16 WITH FACTORY BIRD SCREEN, CURB WITH BOTTOM SLOPED TO MATCH ROOF SLOPE, AND BACK-DRAFT DAMPER. TRANSITION FROM DUCT SIZE SHOWN ON FLOOR PLAN (M2.1) TO FULL-SIZE EQUIPMENT OPENING SIZE ROOF DECK. COORDINATE LOCATION WITH EXISTING FLUE VENT LOCATIONS AND TO BE WITHIN VOID SPACE BETWEEN ROOF STRUCTURAL JOIST/RAFTERS.

GENERAL NOTES THIS SHEET

- 1. REFER TO NOTES ON MO.1 FOR ADDITIONAL INSTRUCTIONS.
- 2. MAINTAIN 10-FEET SEPARATION BETWEEN OUTDOOR AIR INTAKE LOCATIONS AND ANY PLUMBING OR FLUE VENT OR EXHAUST AIR DISCHARGE AIR LOCATIONS.

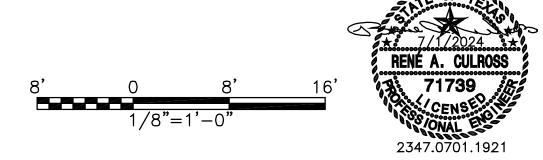

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| 5 07/01/2024 KITCHEN REV | /. | |
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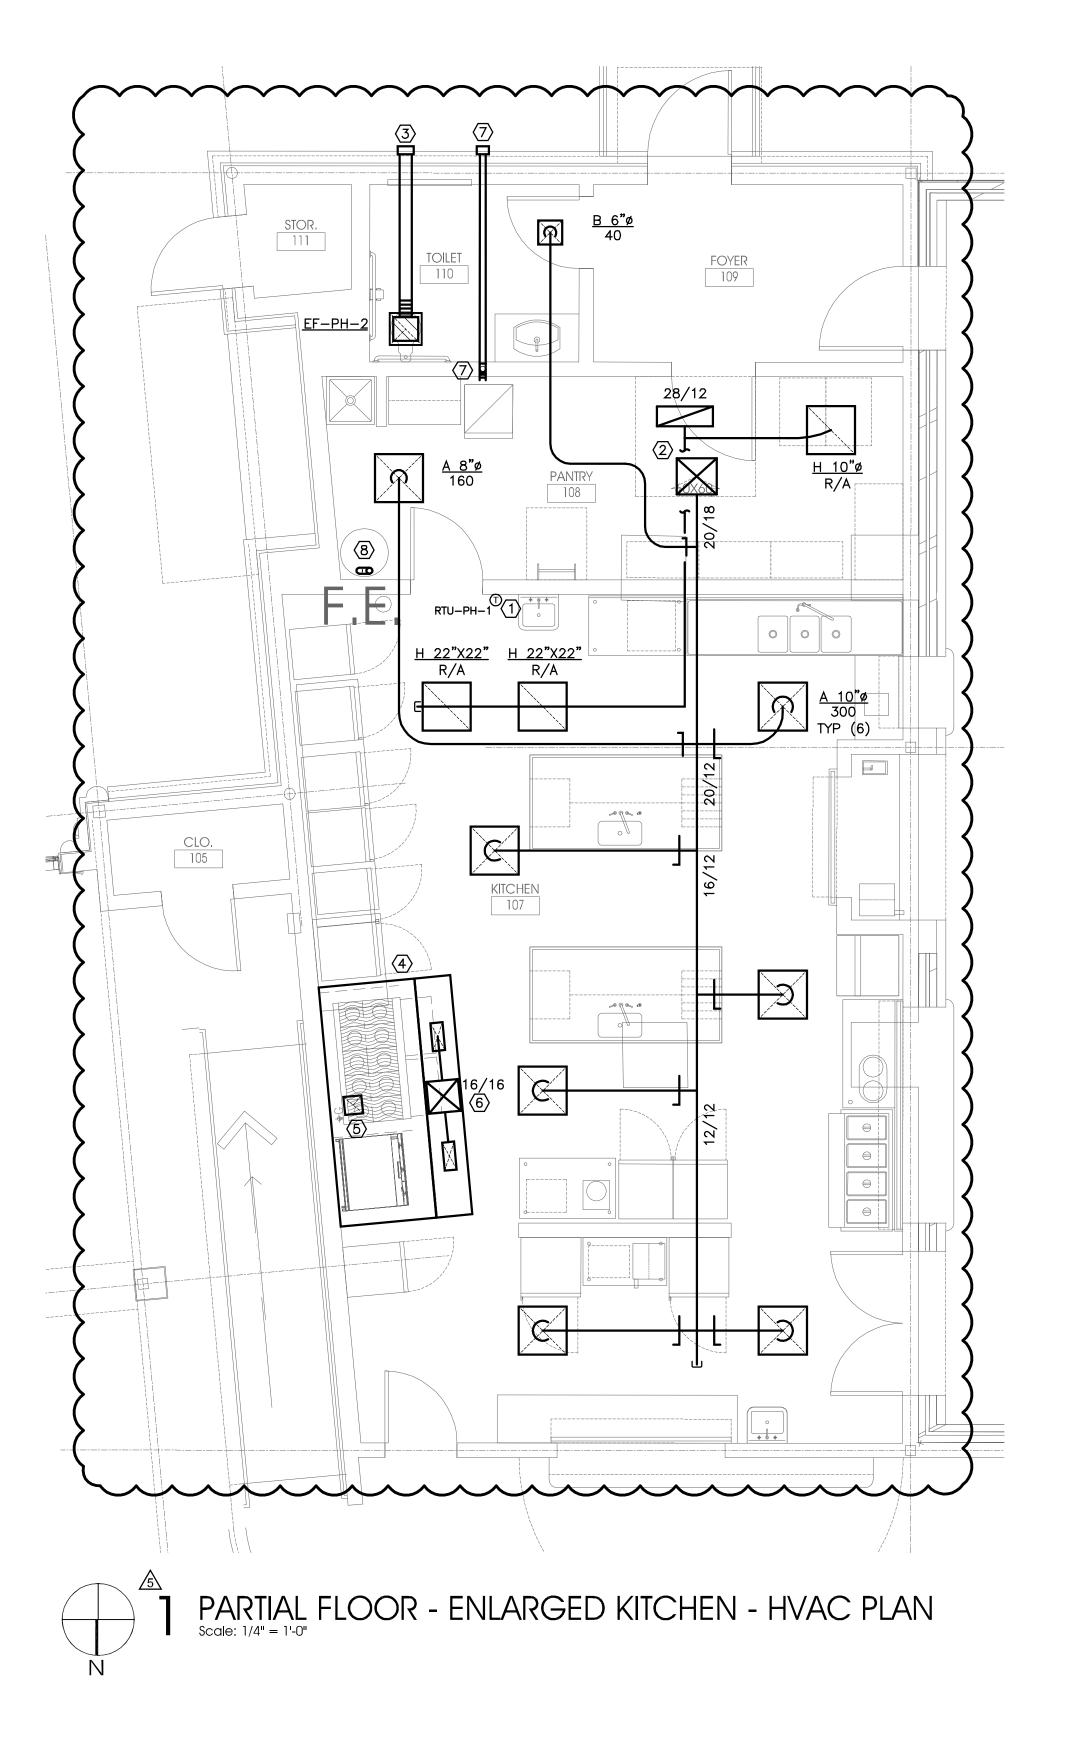
| Drawing Title: | |
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| PARTIAL HVAC | |
| Project No. | Date: |
| 2307 | 1/12/2024 |
| | Sheet No. |
| | M2.2 |


GENERAL NOTES THIS SHEET

- 1. REFER TO MO.1 FOR ADDITIONAL INSTRUCTIONS.
- 2. RUN-OUTS TO AIR DEVICES ARE SAME AS NECK SIZE NOTED ON PLAN UNLESS OTHERWISE NOTED.

NOTES BY SYMBOL "()"

- COORDINATE FINAL LOCATION OF THERMOSTAT WITH OWNER (VIA ARCHITECT) PRIOR TO INSTALLATION. PROVIDE REMOTE TEST SWITCH FOR DUCT DETECTOR(S) ADJACENT TO THERMOSTAT UNIT.
- TRANSITION FROM FULL—SIZE ROOFTOP UNIT SUPPLY/RETURN AIR OPENING TO/FROM SIZE SHOWN ON PLAN AT ROOF DECK. REFER TO M2.2 FOR CONTINUATION. REFER TO DETAIL 1/M4.1 3/M4.1 FOR ADDITIONAL INSTRUCTIONS.
- ROUTE 6-INCH DIAMETER RIGID ROUND DUCT TO MANUFACTURER'S STANDARD WALL CAP.
- TYPE I KITCHEN HOOD WITH SINGLE PLENUM SUPPLY; (DELEGATED DESIGN) UL LISTED, FULLY INTEGRATED PACKAGE DESIGNED BY CAPTIVEAIRE OR APPROVED EQUAL; PRE-ENGINEERED FOR OPTIMUM PERFORMANCE. THE PACKAGE CONSISTS OF THE HOOD, AN INTEGRAL UTILITY CABINET, FACTORY PRE-WIRED ELECTRICAL CONTROLS, AND A LISTED FIRE SUPPRESSION SYSTEM. EXHAUST FAN (PH-KEF-1) AND SUPPLY FAN (PH-KSF-1) SHALL BE MATCHED TO HOOD, AS REQUIRED FOR A COMPLETE AND INTEGRATED SYSTEM. REFER TO FAN SCHEDULE ON MO.3 FOR BASIS OF DESIGN MODEL SERIES.
- TRANSITION FROM FULL EXHAUST CONNECTION SIZE AT HOOD TO FAN OPENING SIZE AT ROOF DECK. GREASE LADEN DUCT SHALL SLOPE A MINIMUM OF 1/4—INCH PER FOOT TOWARDS HOOD.
- TRANSITION TO SIZE NOTED ON PLAN FROM FULL SUPPLY FAN DISCHARGE SIZE AT ROOF DECK. DUCT SIZE NOTED IS BASED ON DESIGN BASIS SUPPLY FAN (1,600 CFM).
- FULL—SIZE DRYER EXHAUST UP IN WALL TO EXTERIOR WALL, REFER TO DETAIL 4/M4.1 FOR DRYER BOX DETAIL. TERMINATE WITH FULL—SIZE DRYER VENT WALL CAP WITH INTEGRAL BACK—DRAFT DAMPER, PAINT CAP TO MATCH ADJACENT SURFACE COLOR, DRYER DUCT SHALL BE SMOOTH RIGID ROUND DUCT WITHOUT SEAMS OR SCREWS.
- ROUTE FULL—SIZE FLUE/INTAKE TO CONCENTRIC VENT ON ROOF. REFER TO DETAIL 8/M4.1 AND PLUMBING DRAWINGS FOR ADDITIONAL INSTRUCTIONS.



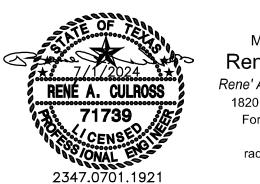

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3 03/28/2024 REVISION 3 - CITY COMMENTS

PERMIT SET

Drawing Title:
PARTIAL FIRST FLOOR HVAC PLANS

Project No.
Date:
1/12/2024

Sheet No.


KITCHEN 107 3"FS 4 7 4 HS1 PARTIAL FLOOR - ENLARGED KITCHEN - U/F PLUMBING PLAN

NOTES BY SYMBOL "1"

- 3-INCH VENT UP.
- $\langle 2 \rangle$ 2-INCH WASTE FROM PLUMBING FIXTURE.
- $\overline{3}$ REFER TO P2.1 FOR CONTINUATION.
- 4 3-INCH WASTE FROM PLUMBING FIXTURE, 2-INCH VENT UP.
- $\langle \overline{b} \rangle$ 4-INCH WASTE FROM PLUMBING FIXTURE; 2-INCH VENT UP.
- $|\langle 6 \rangle$ 1/2-INCH COLD AND HOT WATER FROM ABOVE; 2-INCH VENT UP.
- 7 1/2-INCH COLD AND HOT WATER UP TO PLUMBING FIXTURE (8) 2-INCH WASTE FROM PLUMBING FIXTURE; 2-INCH VENT UP.

GENERAL NOTES THIS SHEET

- 1. REFER TO PO.1 FOR ADDITIONAL INSTRUCTIONS.
- 2. COORDINATE ALL PLUMBING WITH OWNER/ARCHITECT PRIOR TO PURCHASING THE FIXTURE.

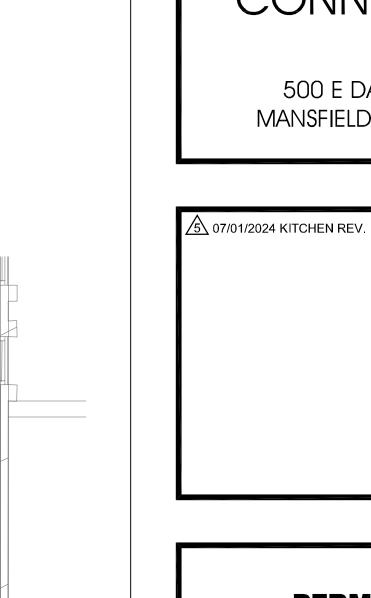

PERMIT SET

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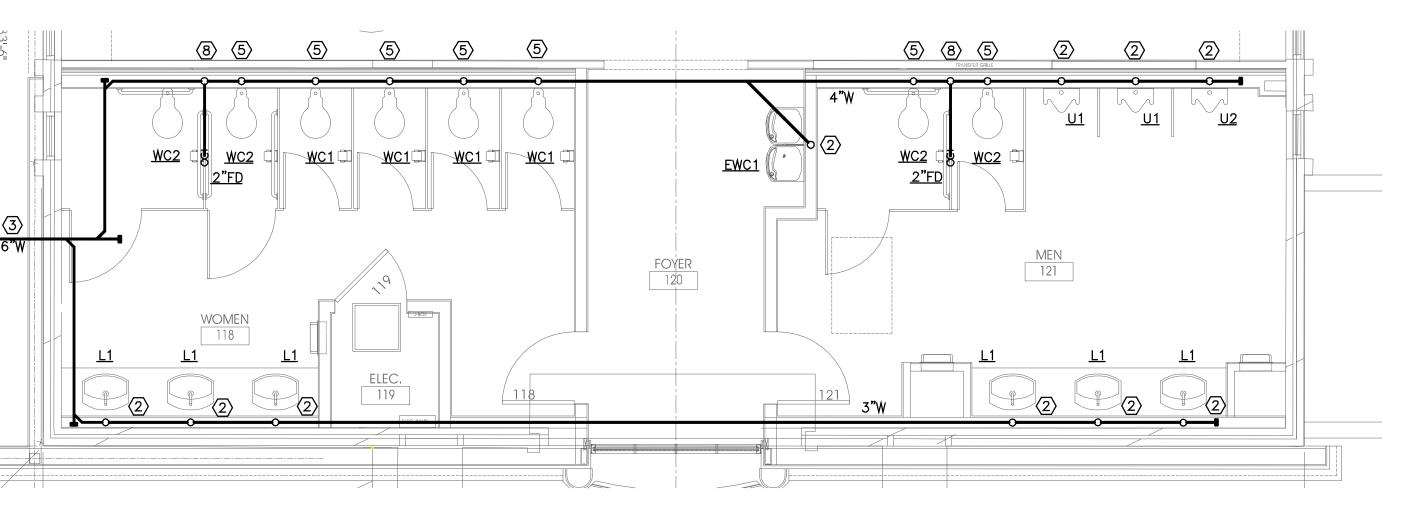
Drawing Title: PARTIAL FIRST FLOOR -UNDERFLOOR PLUMBING PLANS Date: Project No.

2307

Sheet No.

1/12/2024

ST. JUDE CATHOLIC CHURCH PARISH HALL



PARTIAL FLOOR - ENLARGED RESTROOM - U/F PLUMBING PLAN Scale: 1/4" = 1'-0"



817-798-6642

F-12230

FOYER 109 <u>WC2</u> WMB (4) /-3/4"CW 60X60 108 1/2"HW <u>PCO</u> 10 3"FS 3"FS G---3"FS -------PARTIAL FLOOR - ENLARGED KITCHEN - PLUMBING PLAN

NOTES BY SYMBOL "T"

- 3/4-INCH COLD WATER TO PLUMBING FIXTURE; 2-INCH WASTE DOWN, 2-INCH VENT UP.
- 2) 1/2-INCH COLD WATER TO PLUMBING FIXTURE; 1 1/2 VENT UP, 2-INCH
- 1/2-INCH COLD WATER TO IWH AND EACH LAVATORY; ROUTE 1/2-INCH HOT WATER FROM IWH TO EACH LAVATORY. REFER TO DETAIL 5/P4.1 FOR ADDITIONAL INSTRUCTIONS.
- 2 2-INCH WASTE FROM PLUMBING FIXTURE; 1 1/2-INCH VENT UP.
- 23 2-INCH WASTE FROM BELOW.
- 2-INCH WASTE DOWN, 2-INCH VENT UP WITH CLEAN-OUT AT BASE OF
- 1/2-INCH COLD WATER TO PLUMBING FIXTURE.
- 26 1/2-INCH COLD WATER UP TO PLUMBING FIXTURE, REFER TO P2.2 FOR ADDITIONAL INSTRUCTIONS,
- ⟨¬¬⟩ REFER TO P2.1 FOR CONTINUATION.
- ROUTE FULL-SIZE DRAIN ALONG WALL TO DISCHARGE INDIRECTLY AT FLOOR SINK UNDER 3-COMPARTMENT SINK. SLOPE PIPING MINIMUM 1/8-INCH PER FOOT TOWARDS DRAIN.
- 1/2-INCH HOT AND COLD WATER TO PLUMBING FIXTURE.
- 3/4-INCH COLD WATER TO DISHWASHER. PROVIDE BACKFLOW PREVENTION DEVICE (RPZA) WHERE NOT INTEGRAL TO EQUIPMENT. REDUCE/INCREASE TO EQUIPMENT CONNECTION SIZE AS REQUIRED FOR EQUIPMENT TO BE INSTALLED.

GENERAL NOTES THIS SHEET


- 1. REFER TO PO.1 FOR ADDITIONAL INSTRUCTIONS.
- 2. COORDINATE ALL PLUMBING WITH OWNER/ARCHITECT PRIOR TO PURCHASING THE FIXTURE.

NOTES BY SYMBOL "()"

- (1) 3-INCH VENT FROM BELOW
- (2) 3/4-INCH HOT AND COLD WATER DOWN TO PLUMBING FIXTURE; 2-INCH VENT FROM BELOW.
- (3) 1 1/2-INCH COLD WATER TO PLUMBING FIXTURE; 2-INCH VENT FROM BELOW.
- 4 1/2-INCH HOT AND COLD WATER TO PLUMBING FIXTURE; 2-INCH WASTE DOWN, 1 1/2-INCH VENT UP. REFER TO DETAIL 2/P4.1 FOR ADDITIONAL INSTRUCTIONS.
- 5 1/2-INCH HOT AND COLD WATER TO PLUMBING FIXTURE; 2-INCH WASTE DOWN, 1 1/2-INCH VENT UP.
- (6) 2-INCH COLD CONDENSATE FROM ABOVE; TURN OUT FROM WALL AND DOWN TO DISCHARGE INDIRECTLY AT MOP SINK.
- 3/4-INCH COLD WATER AND 1-INCH GAS (120 MBH) TO IWH-PH-1;
 3/4-INCH HOT WATER FROM IWH-PH-1. PROVIDE REGULATOR IN GAS
 LINE TO MAINTAIN GAS PRESSURE WITHIN MANUFACTURER'S MINIMUM AND
 MAXIMUM GAS PRESSURES (DESIGN BASIS UNIT 4/10.5 INCHES WATER
 COLUMN MIN/MAX RESPECTIVELY). REFER TO DETAIL 4/P4.1 FOR
 ADDITIONAL INSTRUCTIONS.
- 8 ROUTE FULL-SIZE WASTE FROM EACH BASIN OF KITCHEN FIXTURE TO DRAIN INDIRECTLY AT FLOOR SINK.
- 9 1/2-INCH HOT AND COLD WATER DOWN TO PLUMBING FIXTURE; 2-INCH
- 1/2-INCH COLD WATER DOWN TO FILTRATION SYSTEM FOR EQUIPMENT (BEVERAGE- OR OR ICE-MACHINE). PROVIDE REDUCED PRESSURE ZONE ASSEMBLY (RPZA) WHERE BACKFLOW PREVENTION IS NOT INTEGRAL TO EQUIPMENT.
- ROUTE FULL SIZE EQUIPMENT DRAIN (ICE-MAKER OR DISHWASHER) INDIRECTLY TO NEAREST FLOOR SINK.
- 1/2-INCH GAS UP TO EQUIPMENT ON ROOF (90MBH). REFER TO P2.2 FOR CONTINUATION AND ADDITIONAL INSTRUCTIONS.
- EXTEND 1-INCH GAS FROM EXISTING 1-INCH GAS LINE IN ADJACENT ATTIC SPACE; 960MBH ADDED LOAD.

 3-INCH VENT THROUGH ROOF.
- 1/2-INCH COLD AND HOT WATER DOWN IN WALL TO PLUMBING FIXTURE; 2-INCH VENT FROM BELOW. REFER TO 2/P3.1 FOR ADDITIONAL
- INSTRUCTIONS.
- 1/2-INCH COLD AND HOT WATER FROM BELOW AND TO PLUMBING FIXTURE. ROUTE FULL-SIZE DRAIN FROM BASIN TO DISCHARGE INDIRECTLY AT FLOOR SINK.
- 2-INCH VENT FROM BELOW (FLOOR SINK)

 3/4-INCH GAS DOWN TO GAS MANIFOLD FOR KITCHEN EQUIPMENT;
 REFER TO DETAIL 7/P4.1 FOR ADDITIONAL INSTRUCTIONS. COORDINATE FINAL CONNECTION SIZES WITH FINAL EQUIPMENT TO BE INSTALLED (DESIGN BASIS: RANGE/OVENS 480MBH; 120MBH). PROVIDE GAS REGULATOR AT EQUIPMENT, AS REQUIRED.

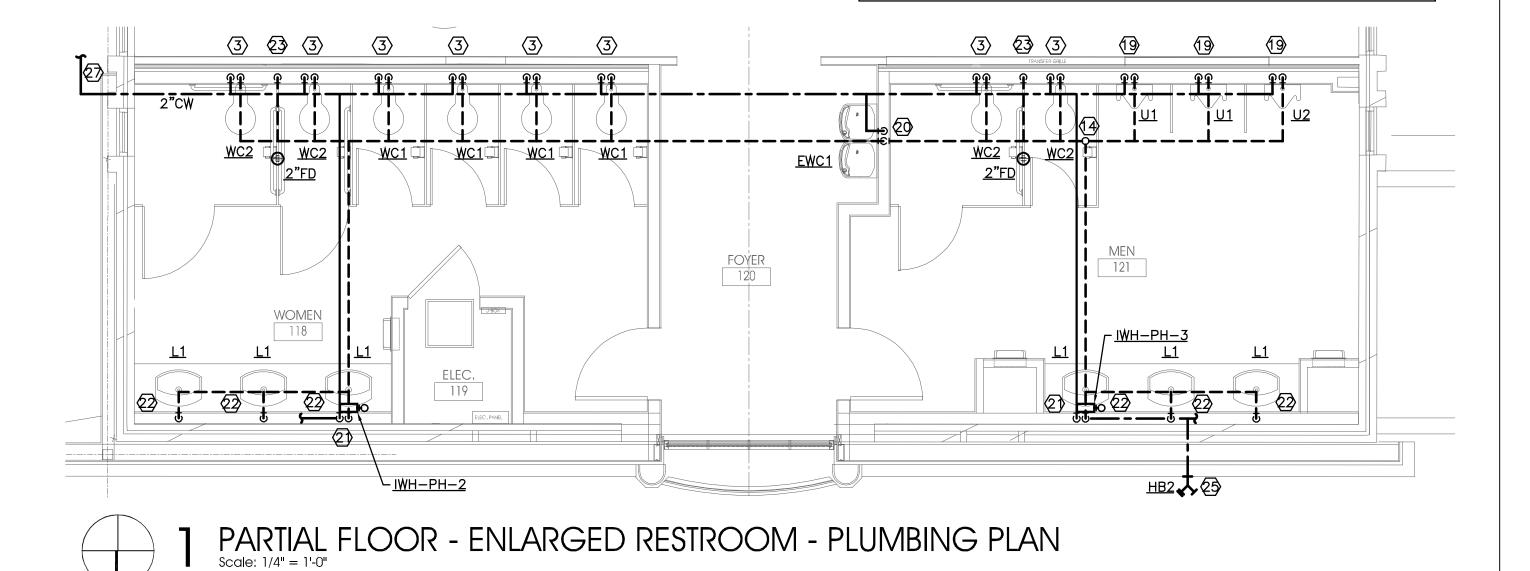



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5 07/01/2024 KITCHEN REV.

PERMIT SET

Drawing Title: PARTIAL FIRST FLOOR -PLUMBING PLANS


Project No. 2307

1/12/2024

Date:

Sheet No.

P3.2

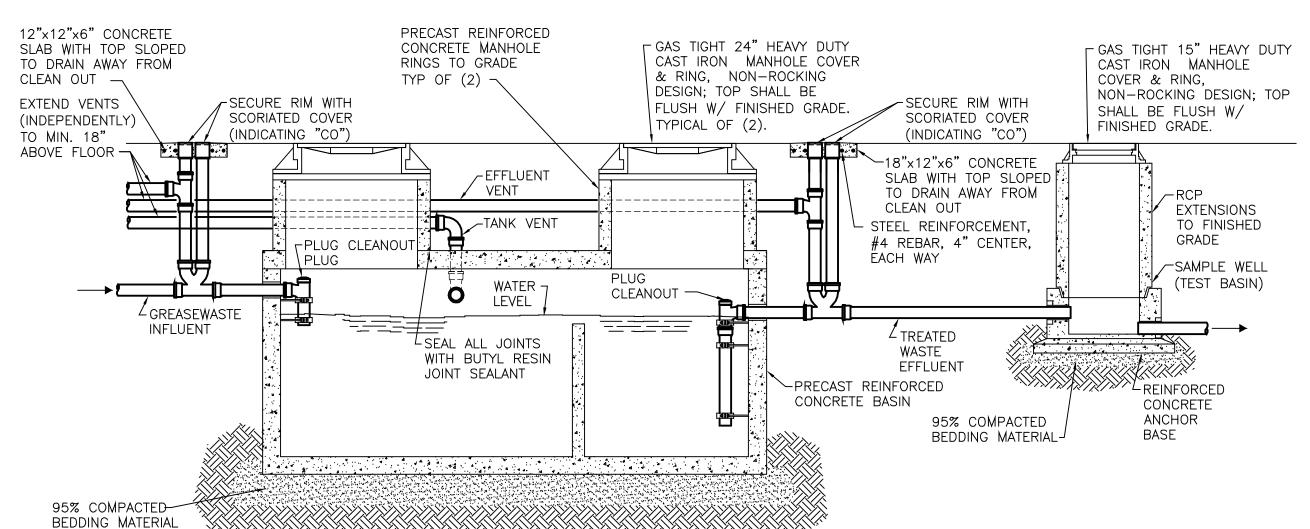

INTERCEPTOR NOTES

- 1. SEAL ALL PIPE PENETRATIONS WATERTIGHT.
- 2. COAT INTERIOR OF BASIN WITH (2) COATS OF POLYURETHANE
- REFER TO PLANS FOR PIPE SIZES, INVERT ELEVATIONS AND ROUTING.
- 4. SECONDARY COMPARTMENT HAS VOLUME EQUAL TO 1/3 OF TOTAL CAPACITY.
- 5. ALL PIPE AND FITTINGS SHALL BE CAST IRON.
- 6. WALLS AND BOTTOM SHALL BE REINFORCED

THROUGHOUT WITH 2x6, 6/10 MESH.

- 7. COVER SHALL BE REINFORCED LONGITUDINALLY WITH NO.6 REBAR ON 6" CENTERS, NO.4 REBAR ON 6" CENTERS WIDTH WAYS, AND NO.8 REBAR DIAGONALLY AROUND ACCESS HOLES.
- 8. GREASE INTERCEPTOR SHALL MEET THE APPROVAL OF LOCAL AUTHORITY.
- 9. MAXIMUM 10'-0" BETWEEN MANHOLES.
- 10. ALL CONSTRUCTION SHALL CONFORM TO H-20 LIVE LOAD LOADING.
- 11. INTERCEPTOR WALLS AND BOTTOM SLAB SHALL BE DESIGNED FOR AN EQUIVALENT FLUID SOIL PRESSURE OF 40 Pcf/ft. INCLUDING TRUCK LOADING SURCHARGE NOTED IN NOTE 10 ABOVE.

GREASE INTERCEPTOR SCHEDULE

GI1, GREASE INTERCEPTOR

GREASE INTERCEPTOR WITH 750 GALLON LIQUID HOLDING CAPACITY, 1,700 LBS. GREASY SLUDGE CAPACITY. INTERCEPTOR SHALL BE 1/4" ALL WELDED STEEL SEPARATOR. INTERCEPTOR SHALL BE PROVIDED WITH VISIBLE DOUBLE WALL OUTSIDE TRAP SEAL, SEPARATOR SCREEN, REMOVABLE FILTER SCREENS, REMOVABLE HEAVY DUTY STEEL PLATE COVER WITH 3/8" NON-SKID DIAMOND TREAD-PLATE COVER WITH HEAVY-DUTY LEAK PROOF GASKETS. PROVIDE EPOXY COATING ON ALL SURFACES. PROVIDE INTEGRAL EXTENSION TO GRADE. INTERCEPTOR SHALL BE EQUAL TO PARK EQUIPMENT MODEL GT-2000.

PROVIDE SAMPLE WELL BASIN (TEST WELL) WITH 15-INCH ACCESS PORT AND 4-INCH SAMPLE PIPE DOWNSTREAM OF GREASE INTERCEPTOR. SAMPLE WELL SHALL BE CLASSIFIED WITH GRADE 60 REINFORCEMENT WITH STEEL REBAR CONFORMING TO ASTM A615. MANHOLE FRAME AND COVER SHALL BE GRAY CAST IRON CONFORMING TO ASTM A48-76, CLASS 30. MANHOLE COVER SHALL BE NOMINAL 24 INCH DIAMETER AND BE HEAVY TRAFFIC DUTY WITH MANHOLE COVER LABELED "SAMPLE WELL". SAMPLE WELL BASIN SHALL BE EQUAL TO PARK EQUIPMENT, SWB-154.

GREASE INTERCEPTOR SIZING

SIZING CALCULATION BASED ON IPC SECTION 1003.3.5.1
PER TABLE 1003.3.5.1: @25 GPM, 50 LBS GREASE HOLDING (1,700 LBS PROVIDED)


| Fixture Inlet Size | Quantity | Drainage Fixture Unit Flow (GPM) | Potential Flow (GPM) |
|--------------------|----------|----------------------------------|----------------------|
| 1¼" | 0 | 1 | 0 |
| 1½" | 0 | 2 | 0 |
| 2" | 0 | 3 | 0 |
| 2½" | 0 | 4 | 0 |
| 3" | 5 | 5 | 25 |
| 4" | 0 | 6 | 0 |
| | Tot | al Potential Flow= | 25 |

Formula Description:

Total Potential Flow X 30

Minimum Required Capacity (Gallons) =

750

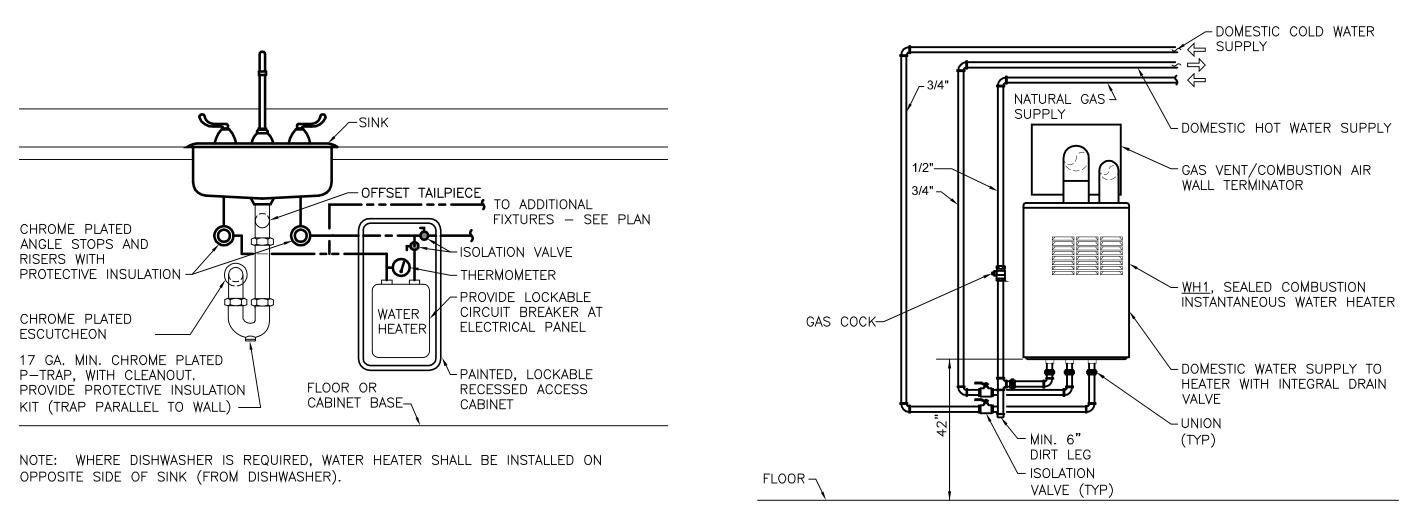



GREASE INTERCEPTOR


SCALE: NO SCALE

INSTANTANEOUS WATER HEATER UNDER SINK

5) SCALE; NO SCALE

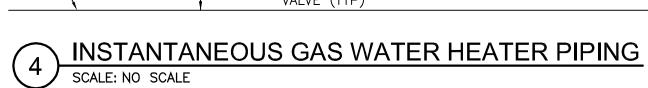


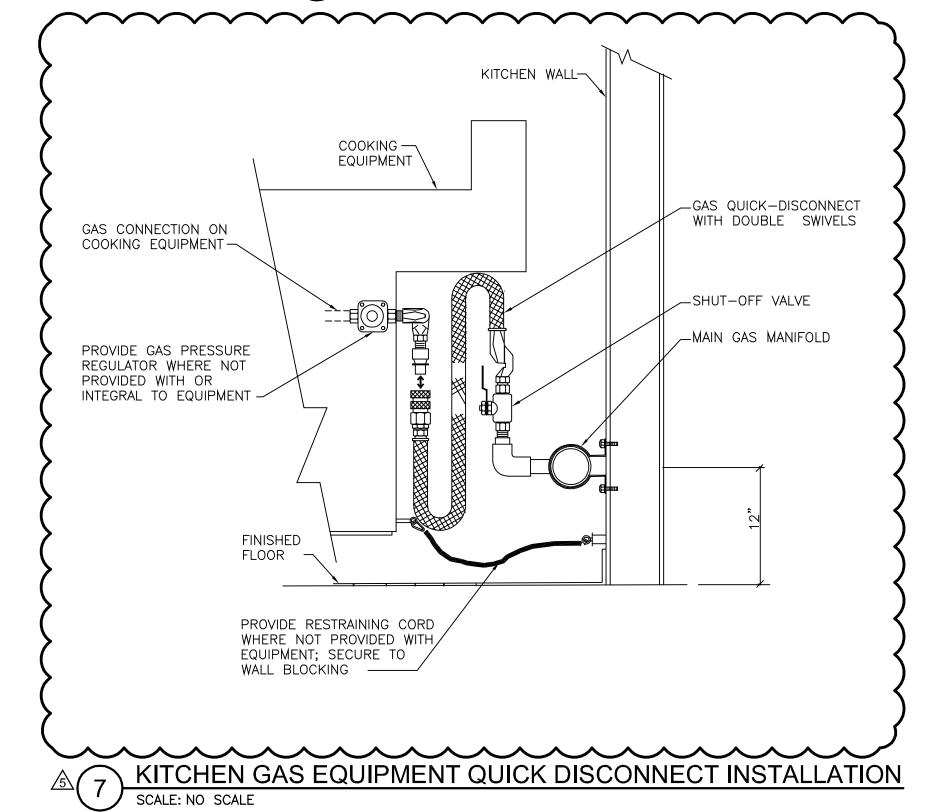

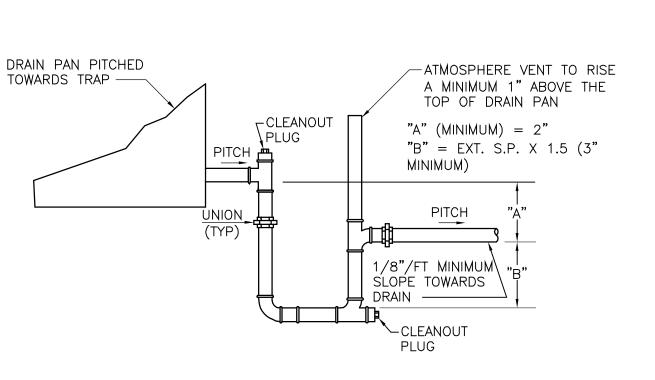


CONDENSATE DRAINAGE

SCALE: NO SCALE

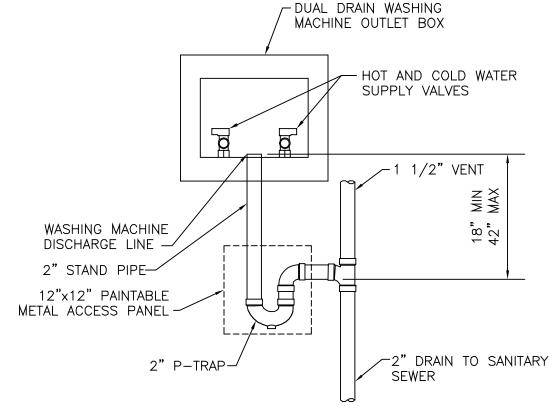

WASHING MACHINE BOX

SCALE: NO SCALE

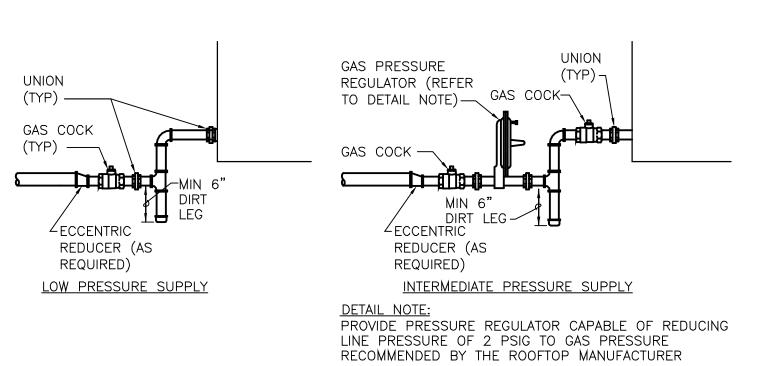

NATURAL GAS CONNECTIONS TO EQUIPMENT
SCALE: NO SCALE



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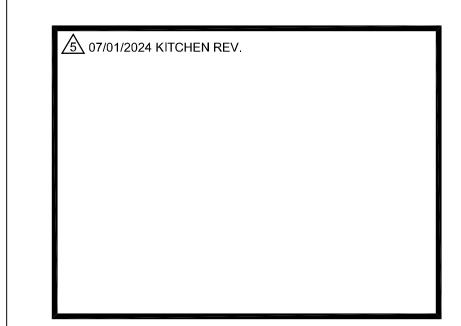
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| Drawing Title: PLUMBIN | NG DETAILS |
|---------------------------|------------|
| Project No. | Date: |
| 2307 | 1/12/2024 |
| | Sheet No. |
| | P4.1 |