DEMOLITION KEYNOTES LOCATION OF EXISTING STEEL COLUMN TO REMAIN. G.C. TO FIELD VERIFY EXACT QUANTITY AND LOCATION OF EXISTING STEEL COLUMNS. PROTECT EXISTING STRUCTURAL SYSTEM OF EXISTING BUILDING TO REMAIN AT ALL TIMES. ANY COLUMNS NOT SHOWN TO BE FIELD VERIFIED AND COORDINATED WITH ARCHITECT. SECTION OF EXISTING MASONRY WALL TO REMAIN AND BE WRAPPED WITH GYP. BD. ON HAT CHANNEL - REF PLAN FOR DETAILS. IN EXISTING FACILITY, MAJOR RENOVATIONS SHALL OCCUR. REMOVE AND HAUL OFFSITE EXISTING INTERIOR CMU WALLS, PARTITIONS, CEILINGS, STUD WALL PARTITIONS, REMOVE EXISTING MECHANICAL, ELECTRICAL AND PLUMBING AND ASSOCIATED COMPONENTS AND PREPARE FOR INSTALLATION OF NEW SYSTEMS - REF. MEP FOR AND SHALL BE PROTECTED FROM DAMAGE. COORDINATE REMOVAL OF INTERIOR ELEMENTS WITH NEW PLAN LAYOUT AND COORDINATE REMOVAL WITH ALL TRADES. MAINTAIN WEATHERTIGHT ENVELOPE AT ALL TIMES. FLOORING TILE HAS BEEN TESTED AND DOES CONTAIN ACM MATERIALS AND WILL BE ABATED BY OWNER PRIOR TO DEMOLITION. G.C. SECTION OF EXISTING MASONRY WALL TO BE REMOVED ONLY AS NECESSARY TO PROVIDE NEW PLAN LAYOUT - REF. NEW PLAN SHEETS FOR DETAILS. WHERE MASONRY WALL REMOVED, EXISTING JOIST AND BEAM SHALL BE SUPPORTED AND NEW STRUCTURE INSTALLATION COORDINATED TO MAINTAIN THE BUILDING SYSTEM AT ALL TIMES. EXISTING STOREFRONT WINDOWS SHALL BE REMOVED AND HAULED OFFSITE. EXISTING MASONRY SHALL REMAIN. EXISTING TROPHY CASE AND ASSOCIATED WALLS AND COMPONENTS SHALL BE REMOVED AND HAULED OFFSITE. PREPARE AREA FOR NEW OFFICES TO BE PROVIDED. REMOVE EXISTING STOREFRONT DOORS, SIDELITES AND TRANSOM AND HAUL OFFSITE. REMOVE EXISTING SITE ELEMENTS INCLUDING RAMPS, FLATWORK AND HANDRAILS AND HAUL OFFSITE. REF CIVIL EXISTING SIDEWALK AND FLATWORK SHALL BE REMOVED AND HAULED OFFSITE. EXISTING FLAGPOLE SHALL BE REMOVED AND DELIVERED TO OWNER FOR FUTURE USE. REF CIVIL SHEETS FOR ADDITIONAL DETAILS. PREPARE AREA FOR NEW CONSTRUCTION AS NECESSARY REMOVE EXISTING FLATWORK AND HAUL OFFSITE AND PREPARE AREA FOR INSTALLATION OF NEW SITEWORK AND BUILDING FOUNDATION AS NECESSARY. PROTECT EXISTING BUILDING TO REMAIN FROM DAMAGE. MAINTAIN POSITIVE DRAINAGE AWAY FROM EXISTING CONSTRUCTION. REF. CIVIL AND FLOOR PLANS FOR ADDITIONAL DETAILS. WHERE NEW WINDOW OR DOOR OCCURS IN EXISTING WALL - SAWCUT OPENING IN EXISTING MASONRY AS NECESSARY FOR NEW WINDOW INSTALLATION. PROVIDE LINTEL IN NEW OPENING - REF. STRL. FOR DETAILS. REF. SHEET A501 FOR OPENING DETAILS. REMOVE EXISTING WINDOW AND FRAME AND PROVIDE MASONRY INFILL TOOTHED IN WITH SALVAGED MASONRY FROM DEMOLITION. NEW GYP. BD. TO OCCUR ON INTERIOR FACE OF WALL. MAINTAIN WEATHERTIGHT ENVELOPE AT REMOVE EXISTING DOOR AND FRAME AND PORTION OF WALL TO ACCOMMODATE NEW FLOOR PLAN LAYOUT AND HAUL OFFSITE. PROTECT EXISTING LINTEL AND EXISTING MASONRY WALLS TO REMAIN. NEW WALL INFILL SHALL OCCUR IN THIS LOCATION AS SHOWN ON FLOOR PLANS. COORDINATE REMOVAL OF EXISTING MASONRY TO BE SALVAGED AND REUSED TO INFILL NEW OPENINGS WITH MATCHING MASONRY. COORDINATE REMOVAL AND INFILL REMOVE EXISTING FLATWORK AS INDICATED ON CIVIL SHEETS AND HAUL OFFSITE. REMOVE PORTION OF NATURAL GROUND AS NECESSARY TO PROVIDE NEW FLATWORK AND CONCRETE WALK OVER - REF. CIVIL SHEETS FOR EXISTING EXTERIOR SOFFIT, PORTION OF ROOF MATERIAL, MASONRY WALL, STEEL COLUMNS AND BEAMS SHALL BE

NEW FLOOR PLAN FOR LOCATIONS.

BUILDING TO BE RELOCATED. REF. MEP FOR ADDITIONAL DETAILS.

TO WORK BEGINNING. REF. MEP FOR ADDITIONAL DETAILS.

CONSTRUCTION - REF. CIVIL FOR DETAILS.

ADDITIONAL DETAILS ON NEW CONSTRUCTION. PREPARE AREA FOR NEW CONSTRUCTION.

REMOVED AND HAULED OFFSITE BACK TO SLAB AND CAPPED - REF. MEP FOR DETAILS.

DAMAGED FLATWORK TO MATCH EXISTING. REF. CIVIL FOR ADDITIONAL DETAILS.


RECEPTACLE LOCATIONS AND REF. FIN. SCHEDULE FOR FINISH DETAILS.


0. EXISTING TRANSFORMER TO BE RELOCATED TO NEW LOCATION OUTSIDE OF NEW BUILDING FOOTPRINT

INFILL TO BE TOOTHED MASONRY INFILL WITH SALVAGED MASONRY FROM DEMOLISHED BRICK VENEER.

REMOVED AND REPLACED WITH NEW STRUCTURAL SYSTEM AS INDICATED ON STRL AND ARCH. NEW FLOOR PLANS. EXISTING JOISTS AND ROOF SYSTEM WILL REMAIN AND BE REUSED - COORDINATE DEMOLITION TO MAINTAIN. REMOVE BRICK VENEER AND STORE FOR REUSE TO INFILL WHERE EXISTING OPENINGS ARE WILL BE INFILLED - REF. 6. EXISTING ELECTRICAL PANELS AND CLOSET TO BE REMOVED AND HAULED OFFSITE. ELECTRICAL SERVICE TO EXISTING KITCHEN EQUIPMENT, HOODS, EXHAUST SYSTEMS AND ASSOCIATED COMPONENTS TO BE REMOVED AND HAULED OFFSITE. COORDINATE REMOVAL WITH OWNER SCHEDULE PRIOR TO BEGINNING OF WORK IN THIS AREA. 8. EXISTING ELEMENTARY, TILT WALL CONSTRUCTION BUILDING, TO BE REMOVED AND HAULED OFFSITE. REMOVE BUILDING, CONNECTING ELEMENTS, FOUNDATIONS AND ALL ASSOCIATED COMPONENTS AND HAUL OFFSITE. REF. CIVIL AND MEP FOR ADDITIONAL DETAILS. PROTECT EXISTING BUILDING TO REMAIN - REF. NEW PLANS FOR TRANSFORMER RELOCATION OR REPLACEMENT TO BE COORDINATED WITH SERVICE PROVIDER. MINIMIZE POWER INTERRUPTION TO EXISTING FACILITIES AND COORDINATE POWER INTERRUPTION SCHEDULE WITH DISTRICT PRIOR EXISTING TRANSFORMER PAD AND FENCING TO REMOVED AND HAULED OFFSITE - PREPARE SUBGRADE FOR NEW 2. REMOVE EXISTING DOOR, FRAME AND SIDELITES AND HAUL OFFSITE. PREPARE AREA FOR NEW MASONRY INFILL. 3. REMOVE EXISTING GREASE TRAPS AND ASSOCIATED PLUMBING AND HAUL OFFSITE - REF. MEP AND CIVIL FOR 24. EXISTING FREEZER WILL BE USED DURING CONSTRUCTION UNTIL NEW COOLERS ARE PROVIDED. EXISTING FREEZER TO BE RELOCATED AND RECONNECTED OUT OF NEW BUILDING FOOTPRINT. FREEZER WILL MOVE APPROXIMATELY 40 FEET +/- TO THE WEST. COORDINATE RELOCATION LOCATION AND SCHEDULE WITH ARCHITECT PRIOR TO 25. EXITING MECHANICAL ROOM CONTAINS WATER HEATERS AND ASSOCIATED COMPONENTS THAT WILL BE REMOVED 6. EXISTING TOILET AREAS SHALL BE DEMOLISHED AS PART OF OVERALL DEMOLITION. FIXTURES AND PIPING SHALL BE REMOVE A PORTION OF EXISTING FLATWORK AND EXISTING CANOPY AND HAUL OFFSITE. SAWCUT FLATWORK AND PROTECT EXISTING FLATWORK TO REMAIN FROM DAMAGE. PREPARE AREA FOR NEW FLATWORK AND CANOPY TO BE OF DEMOLITION. G.C. TO COORDINATE SCHEDULING OF ABATEMENT CONTRACTOR WITH OVERALL PROJECT. 9. EXISTING FLATWORK NOT SHOWN TO BE DEMOLISHED SHALL REMAIN - PROTECT FROM DAMAGE - REPLACE ANY 0. EXSITING BUILDING SOFFIT HAS BEEN TESTED AND DOES INCLUDE ACM MATERIALS. EXISTING SOFFIT ACM WILL BE AS NECESSARY TO INSTALL NEW PLUMBING SYSTEMS AND PATCH BACK WITH NEW CONCRETE SLAB AS SPEC. REF. MEP FOR NEW PLUMBING LOCATIONS AND REQUIRED DEMOLITION AREAS - G.C. TO COORDINATE WITH ALL TRADES WHERE NEW ELECTRICAL POWER AND DATA ARE PROVIDED IN NEW FLOOR PLAN - REMOVE EXISTING GYP. BD. AS NECESSARY TO INSTALL NEW COMPONENTS AND PATCH BACK WITH MATCHING FINISH - RE. MEP FOR NEW 5. PROTECT EXISTING WINDOWS AND DOORS TO REMAIN - REF. NEW FLOOR PLAN FOR ADDITIONAL DETAILS ON NEW STORE FOR REUSE TO INFILL WHERE EXISTING OPENINGS ARE WILL BE INFILLED - REF. NEW FLOOR PLAN FOR

GENERAL DEMOLITION NOTES

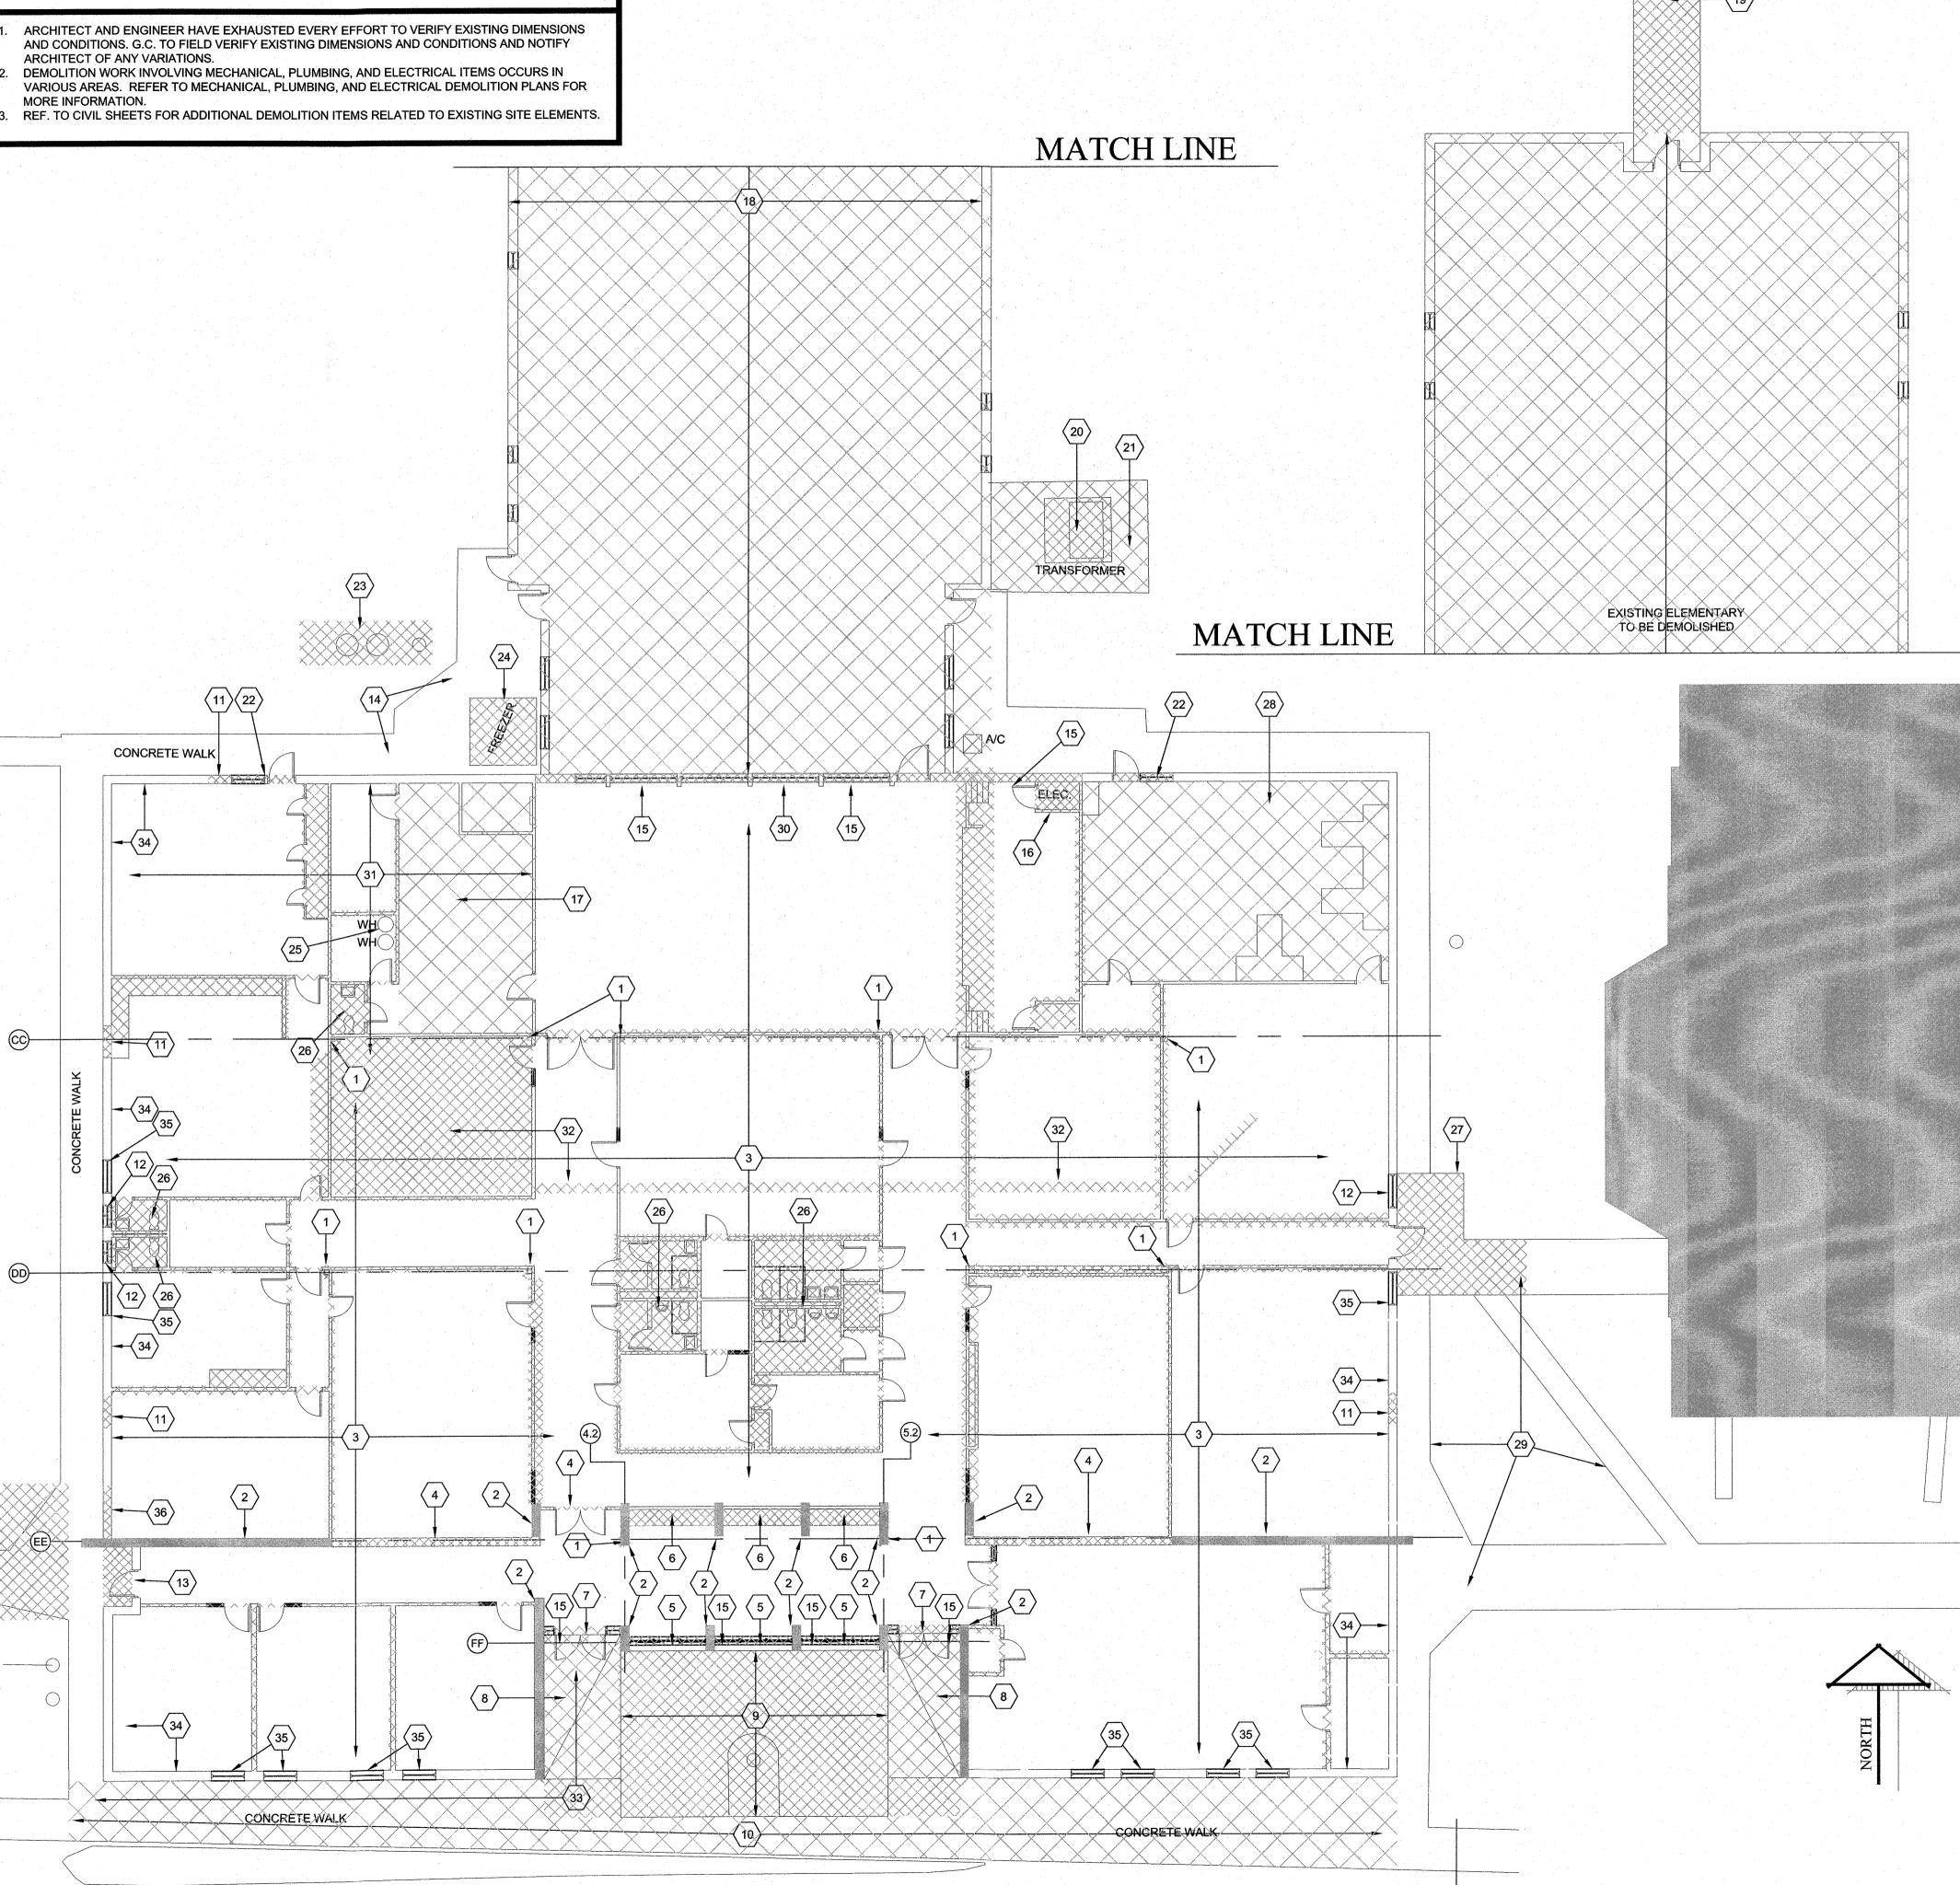

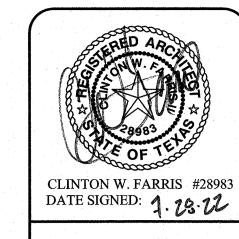


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DRAWN BY: HPA DATE: 28 JULY 2022

20864.00

FLOOR PLAN - DEMOLITION

SCALE 3/32" = 1'-0"

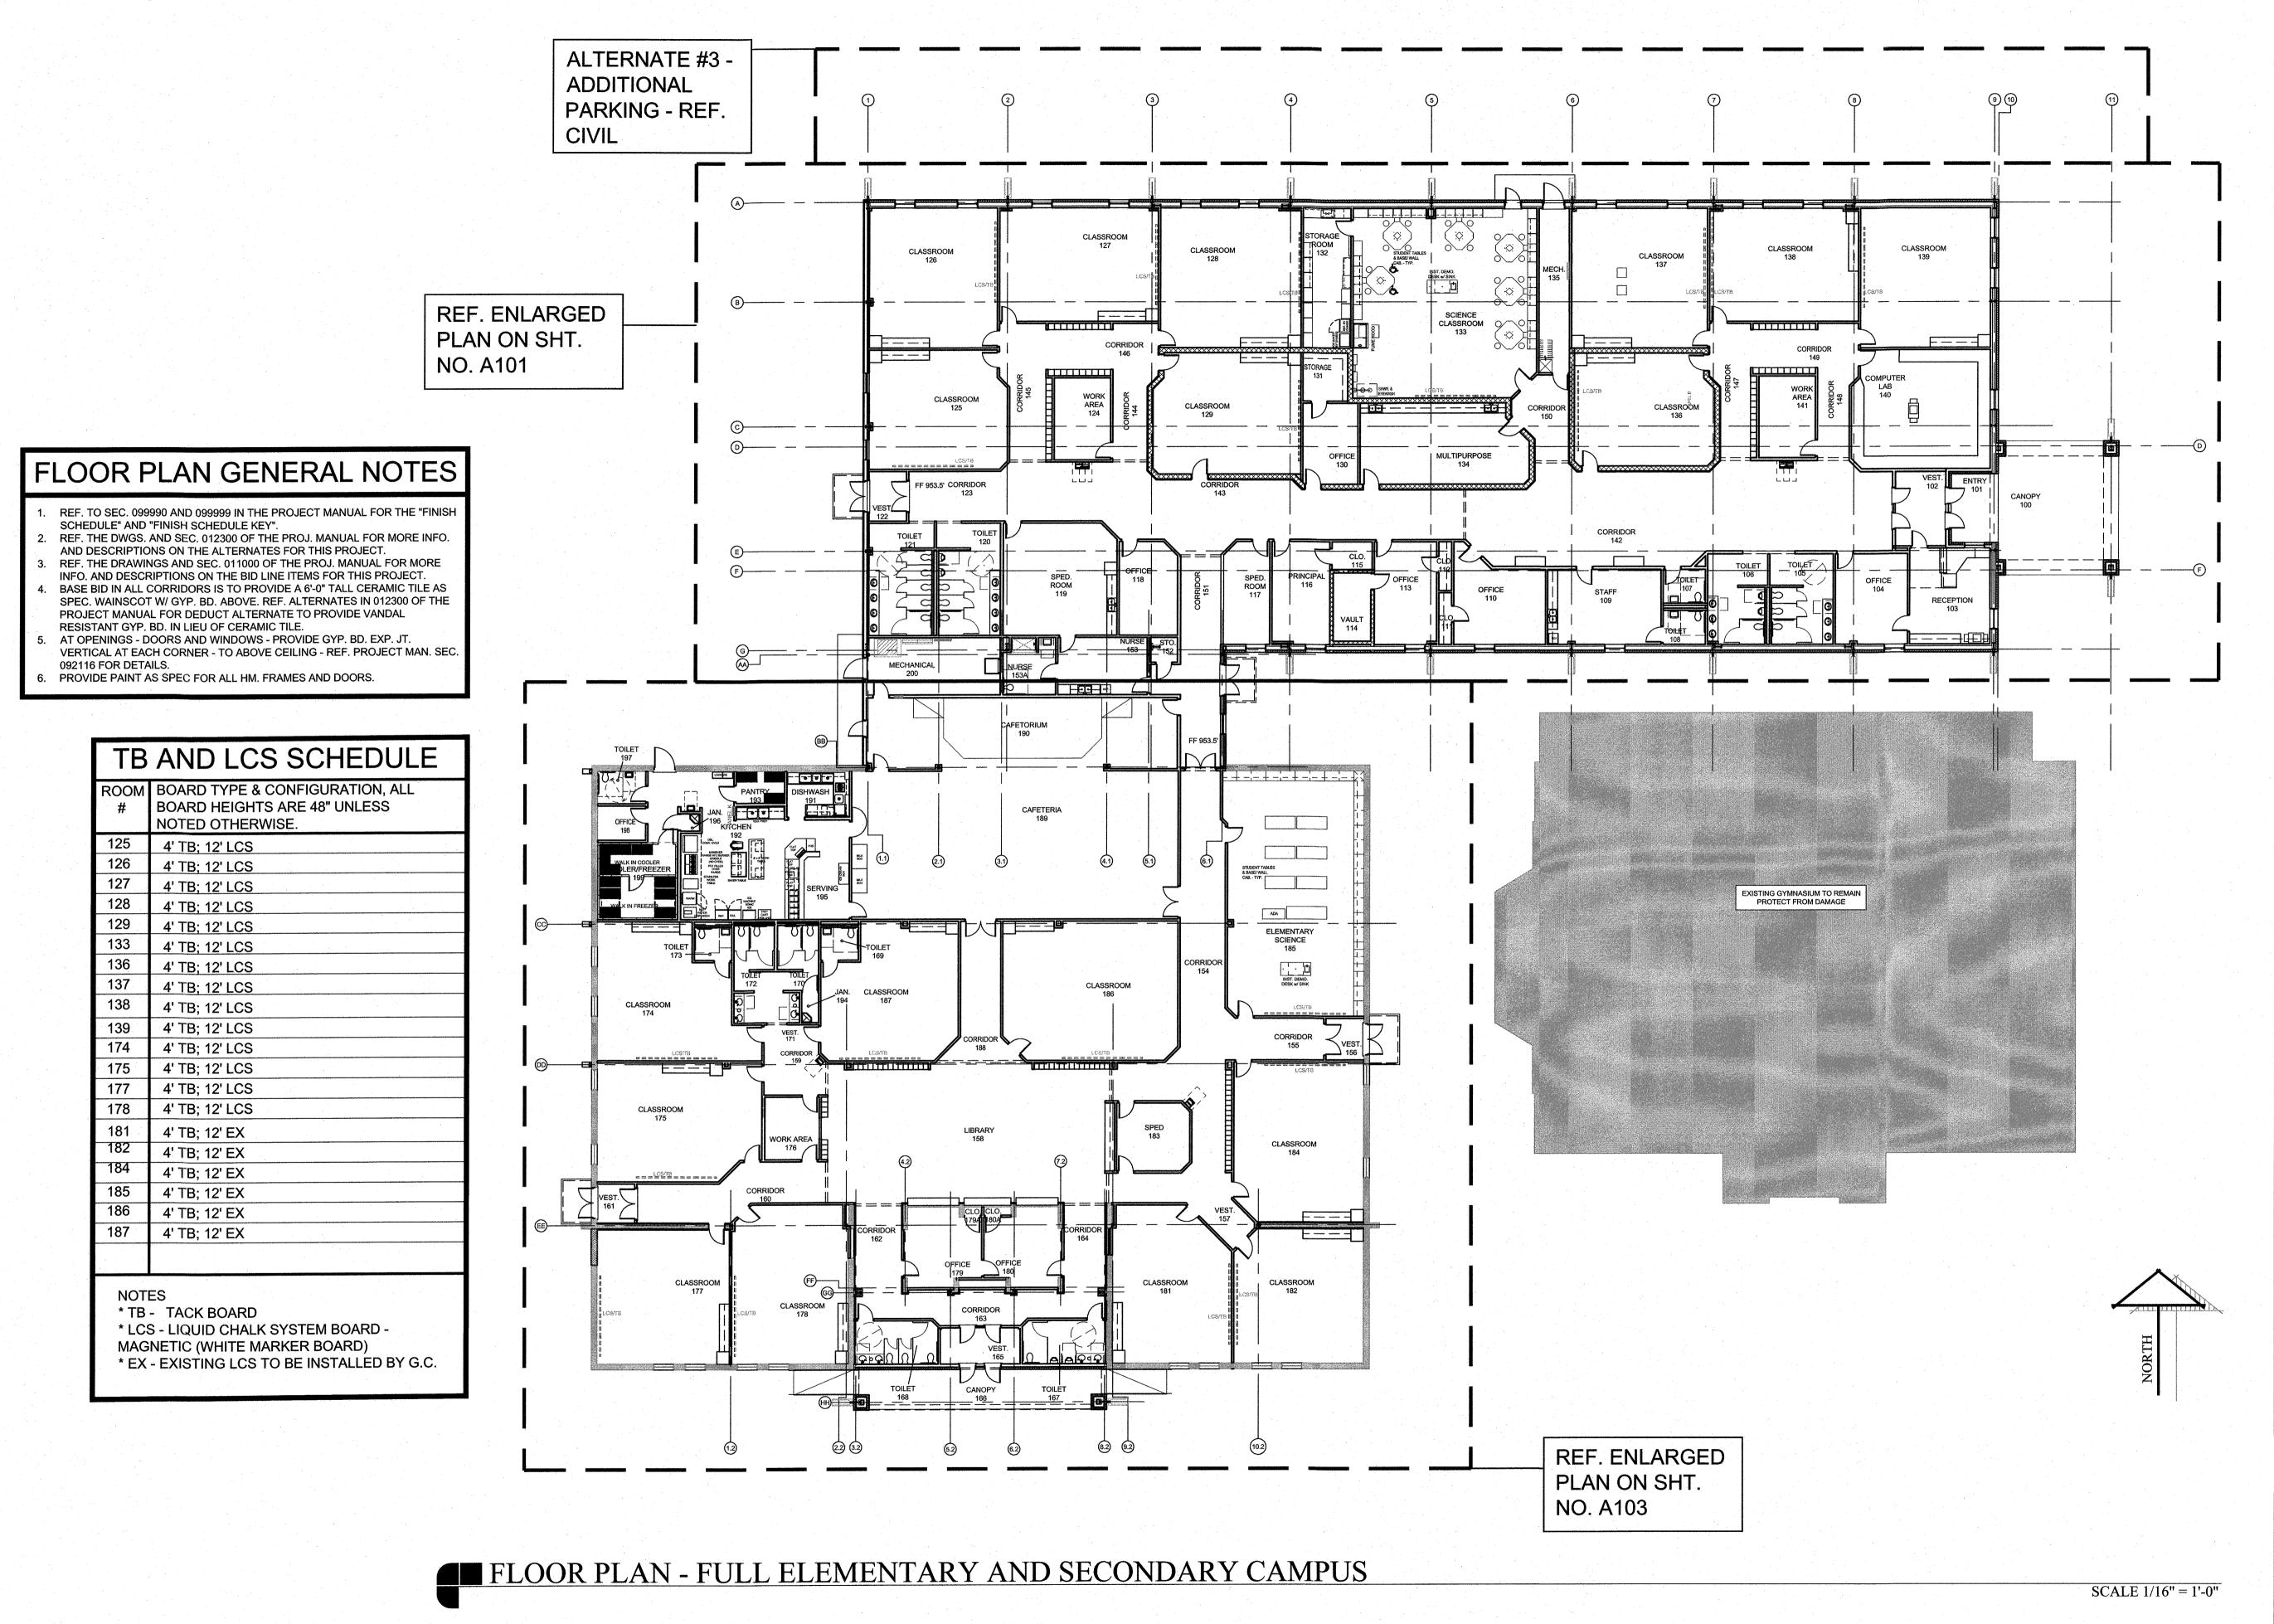

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ARCHITECTS PROGRAMMERS PLANNERS
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CLINTON W. FARRIS #28983

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DRAWN BY: HPA

DATE: 28 JULY 2022

REVISIONS

NO. DESCRIPTION DATE

PROJECT NO. 20864.00

SHEET NO.

□ FLOOR PLAN KEYNOTES □

- LOCATION OF A PRE-FINISHED METAL DOWNSPOUT & SPLASHBLOCK. REF.TO THE "ROOF PLAN" FOR MORE INFO. ON THE D.S. LOCATIONS.
- STL. COL. OR RIGID FR. LOCATION CVR. w/ DRYWALL FURRING COMPOSED OF 3盲 MTL.
- STUDS @ 16" O.C. w/ ONE (1) LAYER OF 5" GYP. BD. TAPE & BED AND FIN. AS SCHED. LOCATION OF NEW GYP. BD. ON 7/8" HAT CHANNEL ATTACHED TO EXISTING WALL, TO CONCEAL EXISTING EXPOSED MASONRY WALL - IN CORRIDORS WHERE TILE WAINSCOT OCCURS - PROVIDE TILE BACKER AS SPEC.
- LOCATION OF NEW GYP. BD. FUR DOWN COORD. FUR DOWN WIDTH WITH WALL TYPES. COORD. BOTTOM OF FUR DOWN ELEVATIONS WITH CEILING HEIGHTS - REFER TO REFLECTED CEILING PLANS AND FIN. SCHED. FOR DETAILS. PROVIDE BOX BEAM ACROSS
- FUR DOWN LOCATION.
- NEW MURAL TO BE PROVIDED IN THIS LOCATION. FINAL SELECTION OF MURAL DESIGN BY OWNER AT A LATER DATE. REF. ALLOWANCES FOR DETAILS. INFILL OPENING IN EXISTING WALL WHERE WINDOW OR DOOR IS REMOVED. USE SALVAGED
- MASONRY FROM DEMOLITION TO INFILL WITH MATCHING MORTAR AND MASONRY. NEW 3 TIER WOOD CUBBIES TO BE PROVIDED IN THIS AREA - NEW CUBBIES EQ. TO "KAPLAN" EARLY LEARNING COMPANY - CAROLINA 4 SECTION LOCKER OR CAROLINA 5 SECTION LOCKER (REF. PLAN FOR LOCATION AND LOCKER QUANTITY AND LAYOUT) - PHONE: 1 800-334-2014, WWW.KAPLANCO.COM
- OWNER PROVIDED MILK BOXES AND ICE CREAM BOX TO REMAIN AND BE REUSED -PROTECT FROM DAMAGE.

FLOOR PLAN GENERAL NOTES

SCHEDULE" AND "FINISH SCHEDULE KEY".

RESISTANT GYP. BD. IN LIEU OF CERAMIC TILE.

REF. TO SEC. 099990 AND 099999 IN THE PROJECT MANUAL FOR THE "FINISH

REF. THE DWGS. AND SEC. 012300 OF THE PROJ. MANUAL FOR MORE INFO.

REF. THE DRAWINGS AND SEC. 011000 OF THE PROJ. MANUAL FOR MORE

BASE BID IN ALL CORRIDORS IS TO PROVIDE A 6'-0" TALL CERAMIC TILE AS

SPEC, WAINSCOT W/ GYP, BD. ABOVE, REF, ALTERNATES IN 012300 OF THE

VERTICAL AT EACH CORNER - TO ABOVE CEILING - REF. PROJECT MAN. SEC.

INFO. AND DESCRIPTIONS ON THE BID LINE ITEMS FOR THIS PROJECT.

PROJECT MANUAL FOR DEDUCT ALTERNATE TO PROVIDE VANDAL

AT OPENINGS - DOORS AND WINDOWS - PROVIDE GYP. BD. EXP. JT.

PROVIDE PAINT AS SPEC FOR ALL HM. FRAMES AND DOORS.

AND DESCRIPTIONS ON THE ALTERNATES FOR THIS PROJECT.

- LOCATION OF NEW ROOF HATCH SCUTTLE TO BE PROVIDED TO ACCESS REF. ROOF PLAN AND A706-01 FOR DETAILS.
- 10. IN THIS AREA SUSPENDED CEILING CLOUDS AND LIGHTING WILL OCCUR REF. REFLECTED CEILING PLANS FOR HEIGHTS AND ADDITIONAL DETAILS.
- 11. LIQUID CHALK SYSTEM (LCS) OR TACKBOARD (TB) UNIT LOCATION G.C. SHALL INSTALL AT A HEIGHT AS DIRECTED BY THE ARCHITECT. REF. TO THE PROJ. MANUAL FOR A LCS/TB SCHEDULE. G.C. TO VERIFY THE FINAL LOCATION OF EA. UNIT w/ THE ARCHITECT PRIOR TO INSTALLATION.
- 12. NEW CONC. RAMP AND STL. HANDRAILING REF. SHTS A202 FOR MORE INFO. 13. NEW 5" RISE CAFETORIUM STAGE AREA TO BE CONSTRUCTED OUT OF 3 5/8" MTL. STD. ON EDGE @ 16" O.C. - ATTACH TO CONCRETE FLOOR. PROVIDE BATT INSULATION IN HORIZONTAL STUD BAY AND TOP W/ 2 LAYERS 3/4" TONGUE AND GROOVE SANDED
- PLYWOOD. PROVIDE NEW CARPET FLOOR TILES AS SPEC. REF. A404-09 FOR DETAILS. 14. LOCATION OF MTL. STD. FRAMED RAMP FROM STAGE TO FINISHED FLOOR - PROVIDE NEW CARPET TILES ON RAMP AS SPEC. REF A404-08 FOR DETAILS.


15. APPROXIMATE LOCATION OF NEW OWNER PROVIDED CEILING MOUNTED PROJECTOR


SCREEN COORD. LOCATION WITH NEW CEILING MOUNTED PROJECTOR - G.C. INSTALL.


- 16. APPROX. LOCATION OF OWNER PROVIDED, G.C. MOUNTED, CEILING MOUNTED PROJECTOR AND MOUNTING PLATE - REF. MEP FOR POWER AND DATA DETAILS. COORD. MOUNTING LOCATION WITH OWNER PROVIDED SCREEN.
- 17. NEW STL. PIPE BOLLARDS OCCUR IN THIS AREA REF. CIVIL FOR LOCATIONS AND BOLLARD
- DETAILS. 18. LOCATION OF MTL. 2 TIER LOCKERS AS SPEC. MOUNTED IN MTL. STUD FRAMING -


COORDINATE FRAMING AND LOCKER BASE WITH LOCKER UNITS TO BE PROVIDED - REF.

- A402-17 AND A305-05 FOR DETAILS. 19. THIS DOOR TO BE EGRESS ONLY - PROVIDE EGRESS HARDWARE ON INTERIOR SIDE OF DOOR ONLY.
- 20. PROVIDE ACCESS CONTROL AT INDICATED LOCATIONS REF. HARDWARE SCHEDULE AND A501 FOR ADDITIONAL DETAILS. COORD. ELECTRICAL AS REQUIRED FOR PROVIDED ACCESS CONTROL SYSTEM - REF. MEP FOR DETAILS.
- 21. IN THIS LOCATION PROVIDE FLOOR ELECTRICAL POWER AND DATA FOR OWNER PROVIDED EQUIPMENT. CORODINATE FINAL LOCATION WITH ARCHITECT. REF. MEP FOR DETAILS. 22. WHERE NEW POWER TO BE PROVIDED IN EXISTING GYP. BD. WALL - PROVIDE MATCHING
- PATCH WHERE DAMAGED OR REMOVED TEXTURE AND PAINT. 23. NEW 6'-0" X 10'-0" CANOPY TO BE PROVIDED AT EGRESS LOCATIONS AS INDICATED EQ. TO MASA ARCHITECTURAL CANOPIES - EXTRUDECK EXTRUDED ALUMINUM CANOPY SYSTEM -
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- 26. IN THIS LOCATION RAISED CORRIDOR CEILING OCCURS PROVIDE MTL. STUD FRAMING W/ GYP BD. BOTH SIDES - REF. SHT A306 FOR DETAILS.
- 27. LOCATION OF OPENING IN CABLE RAIL TO ALLOW ACCESS FROM SHIPS LADDER TO MEZZANINE WOOD DECK.
- 28. OWNER PROVIDED REFRIGERATOR PROVIDE NEW WATER BOX AND POWER REF. MEP
- 29. OWNER PROVIDED ICE MACHINE PROVIDE NEW WATER, DRAIN AND POWER REF. MEP.
- 30. APPROXIMATE LOCATION OF NEW ELECTRICAL PANELS COORD. LOCATION AND

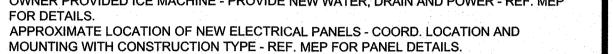

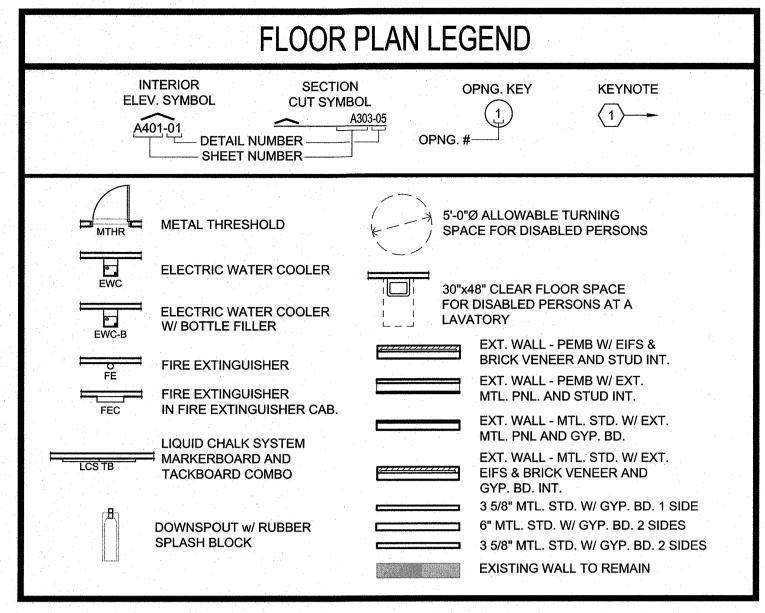

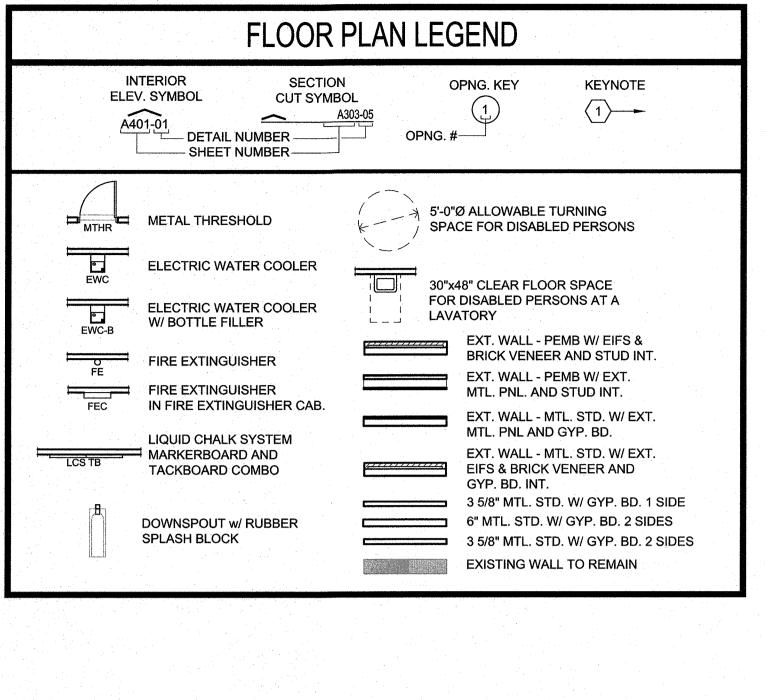

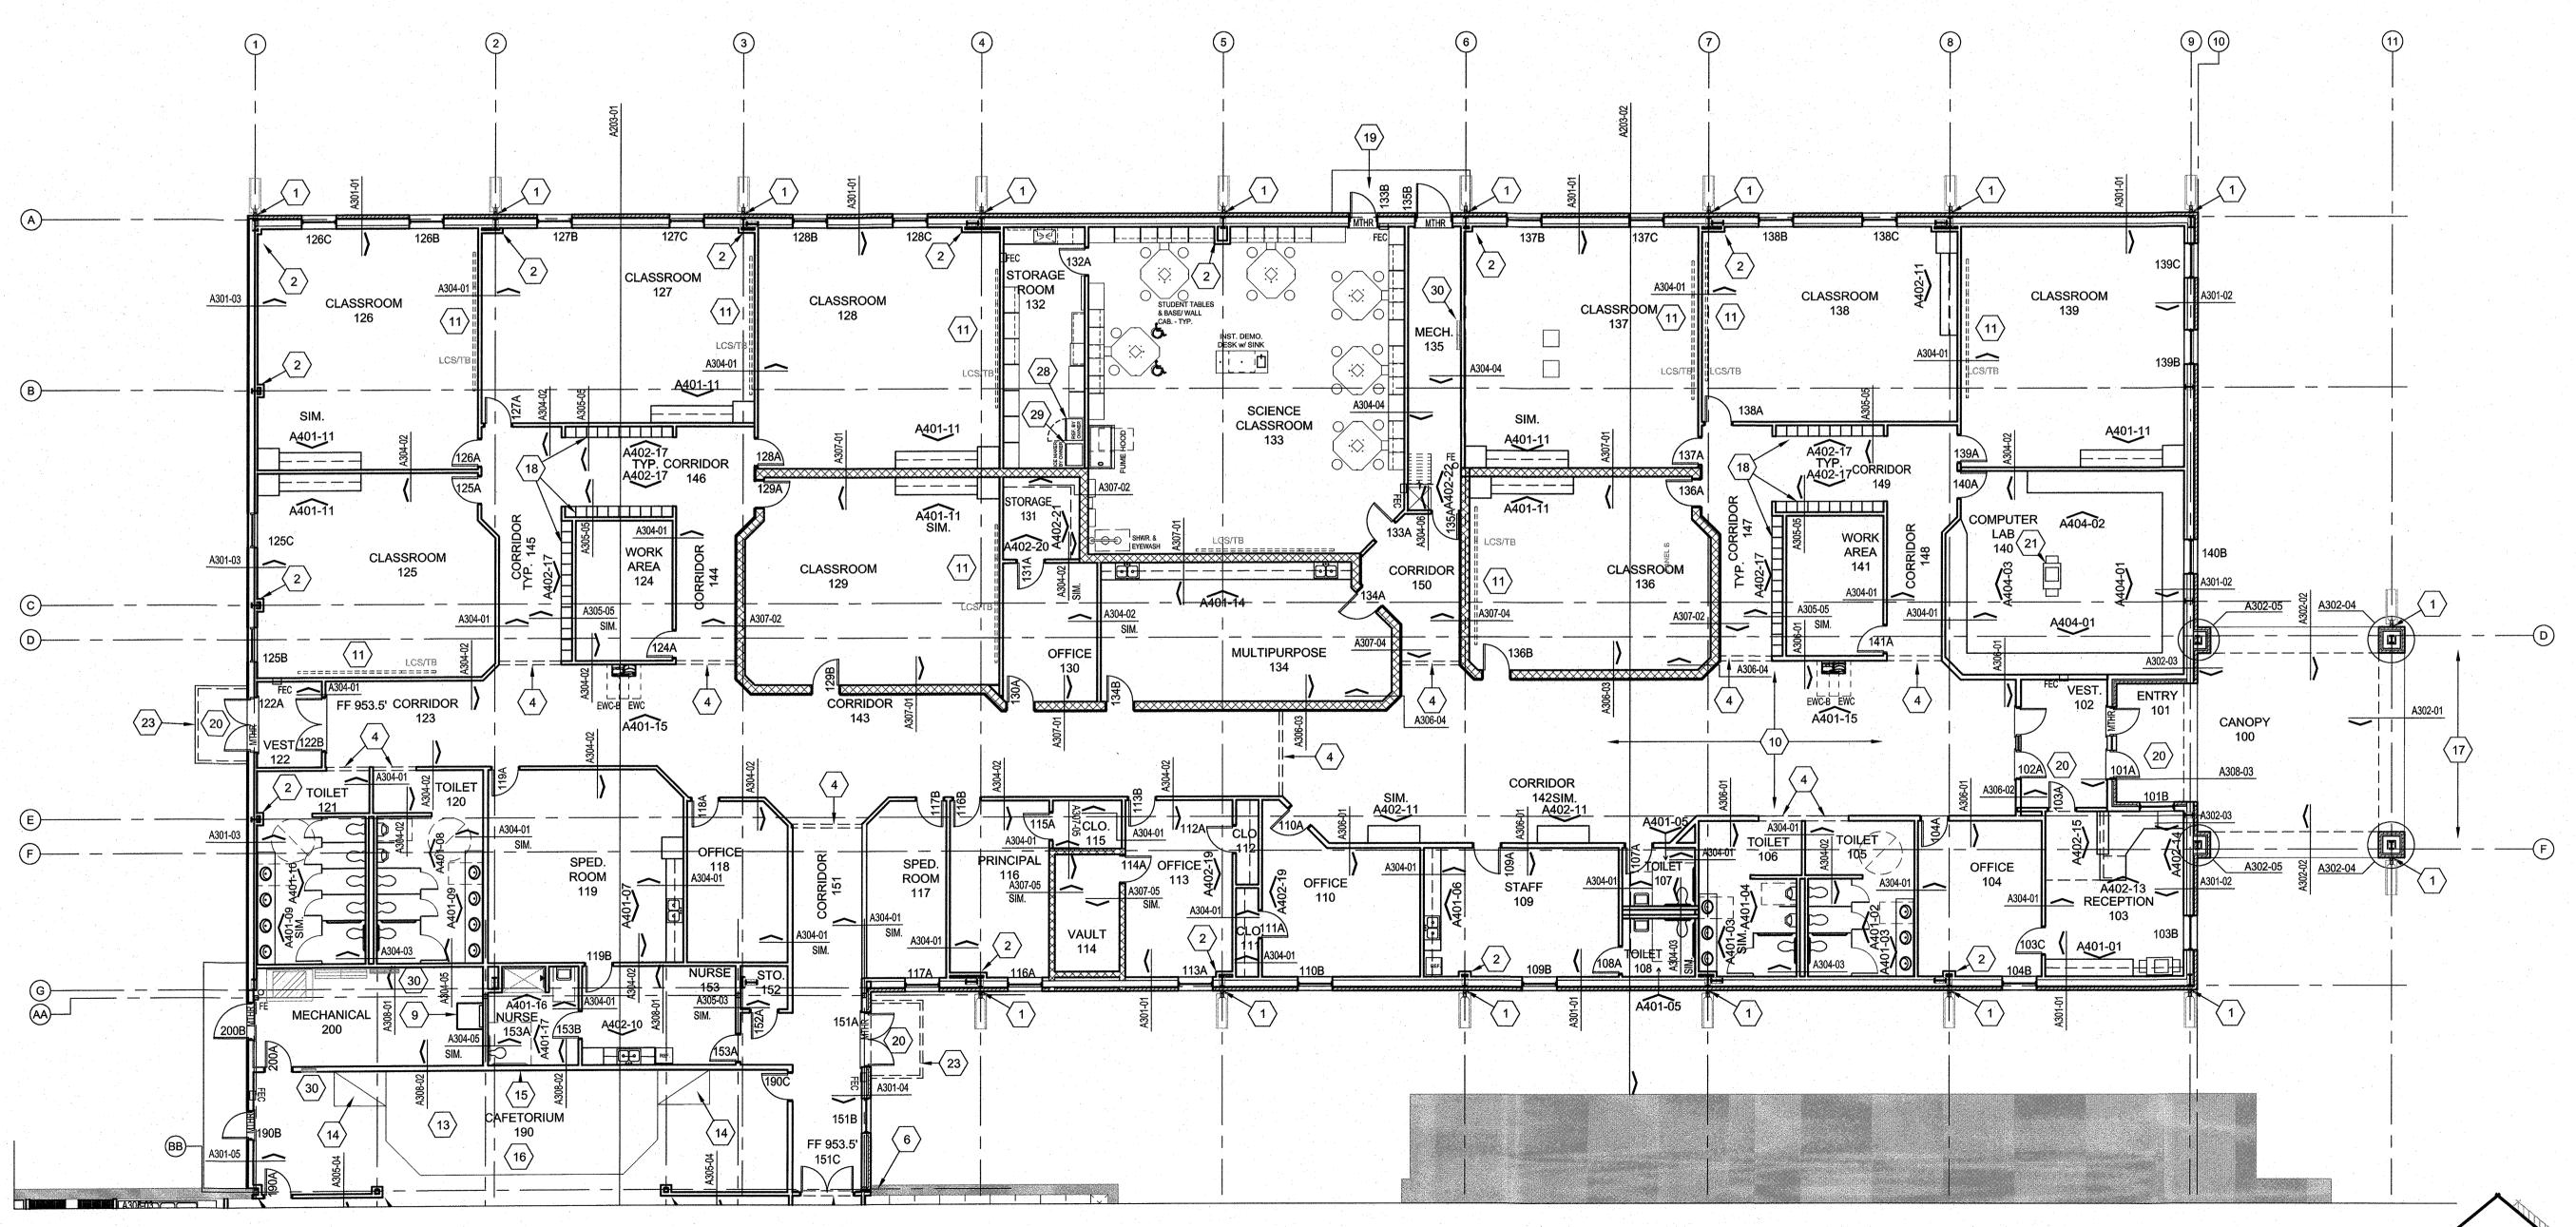

DATE SIGNED: 4. 28.22

ESTABLISHED 1962


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○ FLOOR PLAN KEYNOTES ○

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- 14. LOCATION OF MTL. STD. FRAMED RAMP FROM STAGE TO FINISHED FLOOR PROVIDE NEW CARPET TILES ON RAMP AS SPEC. REF A404-08 FOR DETAILS. 15. APPROXIMATE LOCATION OF NEW OWNER PROVIDED CEILING MOUNTED PROJECTOR

SCREEN COORD. LOCATION WITH NEW CEILING MOUNTED PROJECTOR - G.C. INSTALL.

- 21. IN THIS LOCATION PROVIDE FLOOR ELECTRICAL POWER AND DATA FOR OWNER PROVIDED EQUIPMENT. CORODINATE FINAL LOCATION WITH ARCHITECT. REF. MEP FOR DETAILS. 22. WHERE NEW POWER TO BE PROVIDED IN EXISTING GYP. BD. WALL - PROVIDE MATCHING PATCH WHERE DAMAGED OR REMOVED - TEXTURE AND PAINT.

18. LOCATION OF MTL. 2 TIER LOCKERS AS SPEC. MOUNTED IN MTL. STUD FRAMING -

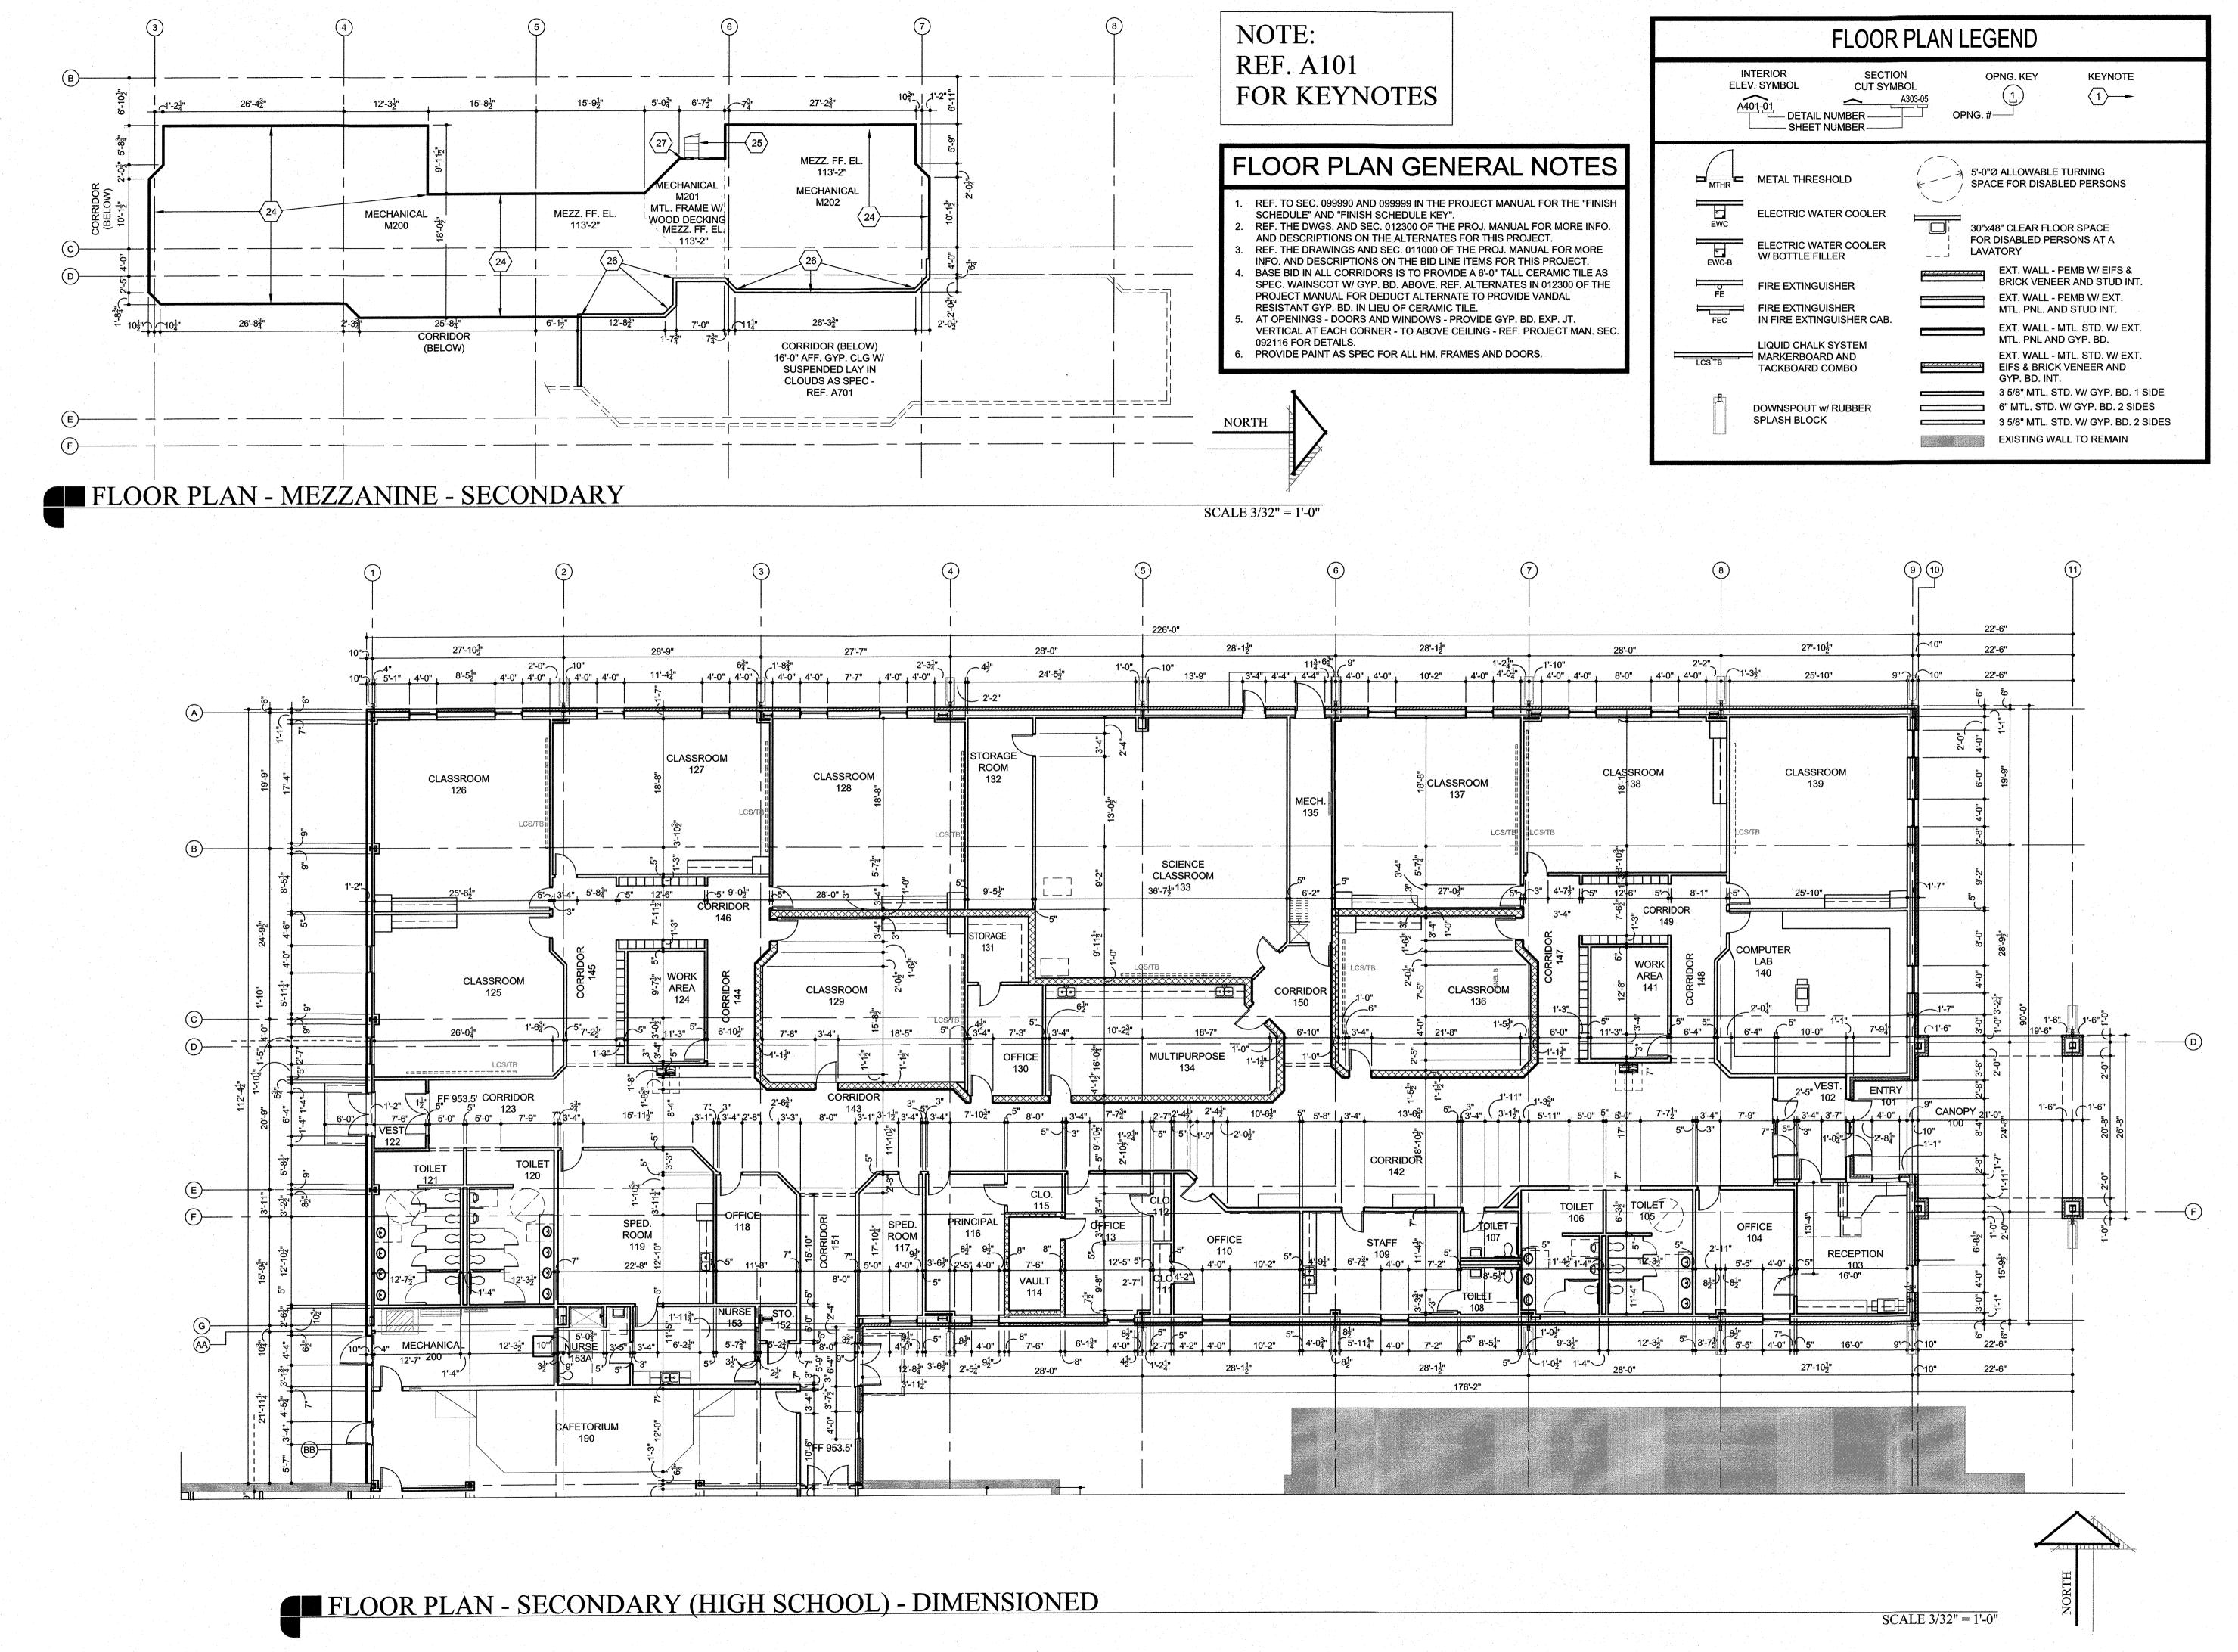16. APPROX. LOCATION OF OWNER PROVIDED, G.C. MOUNTED, CEILING MOUNTED PROJECTOR

LOCATION WITH OWNER PROVIDED SCREEN.

ACCESS CONTROL SYSTEM - REF. MEP FOR DETAILS.

A402-17 AND A305-05 FOR DETAILS.

DOOR ONLY.

FOR DETAILS.

AND MOUNTING PLATE - REF. MEP FOR POWER AND DATA DETAILS. COORD. MOUNTING

17. NEW STL. PIPE BOLLARDS OCCUR IN THIS AREA - REF. CIVIL FOR LOCATIONS AND BOLLARD

COORDINATE FRAMING AND LOCKER BASE WITH LOCKER UNITS TO BE PROVIDED - REF.

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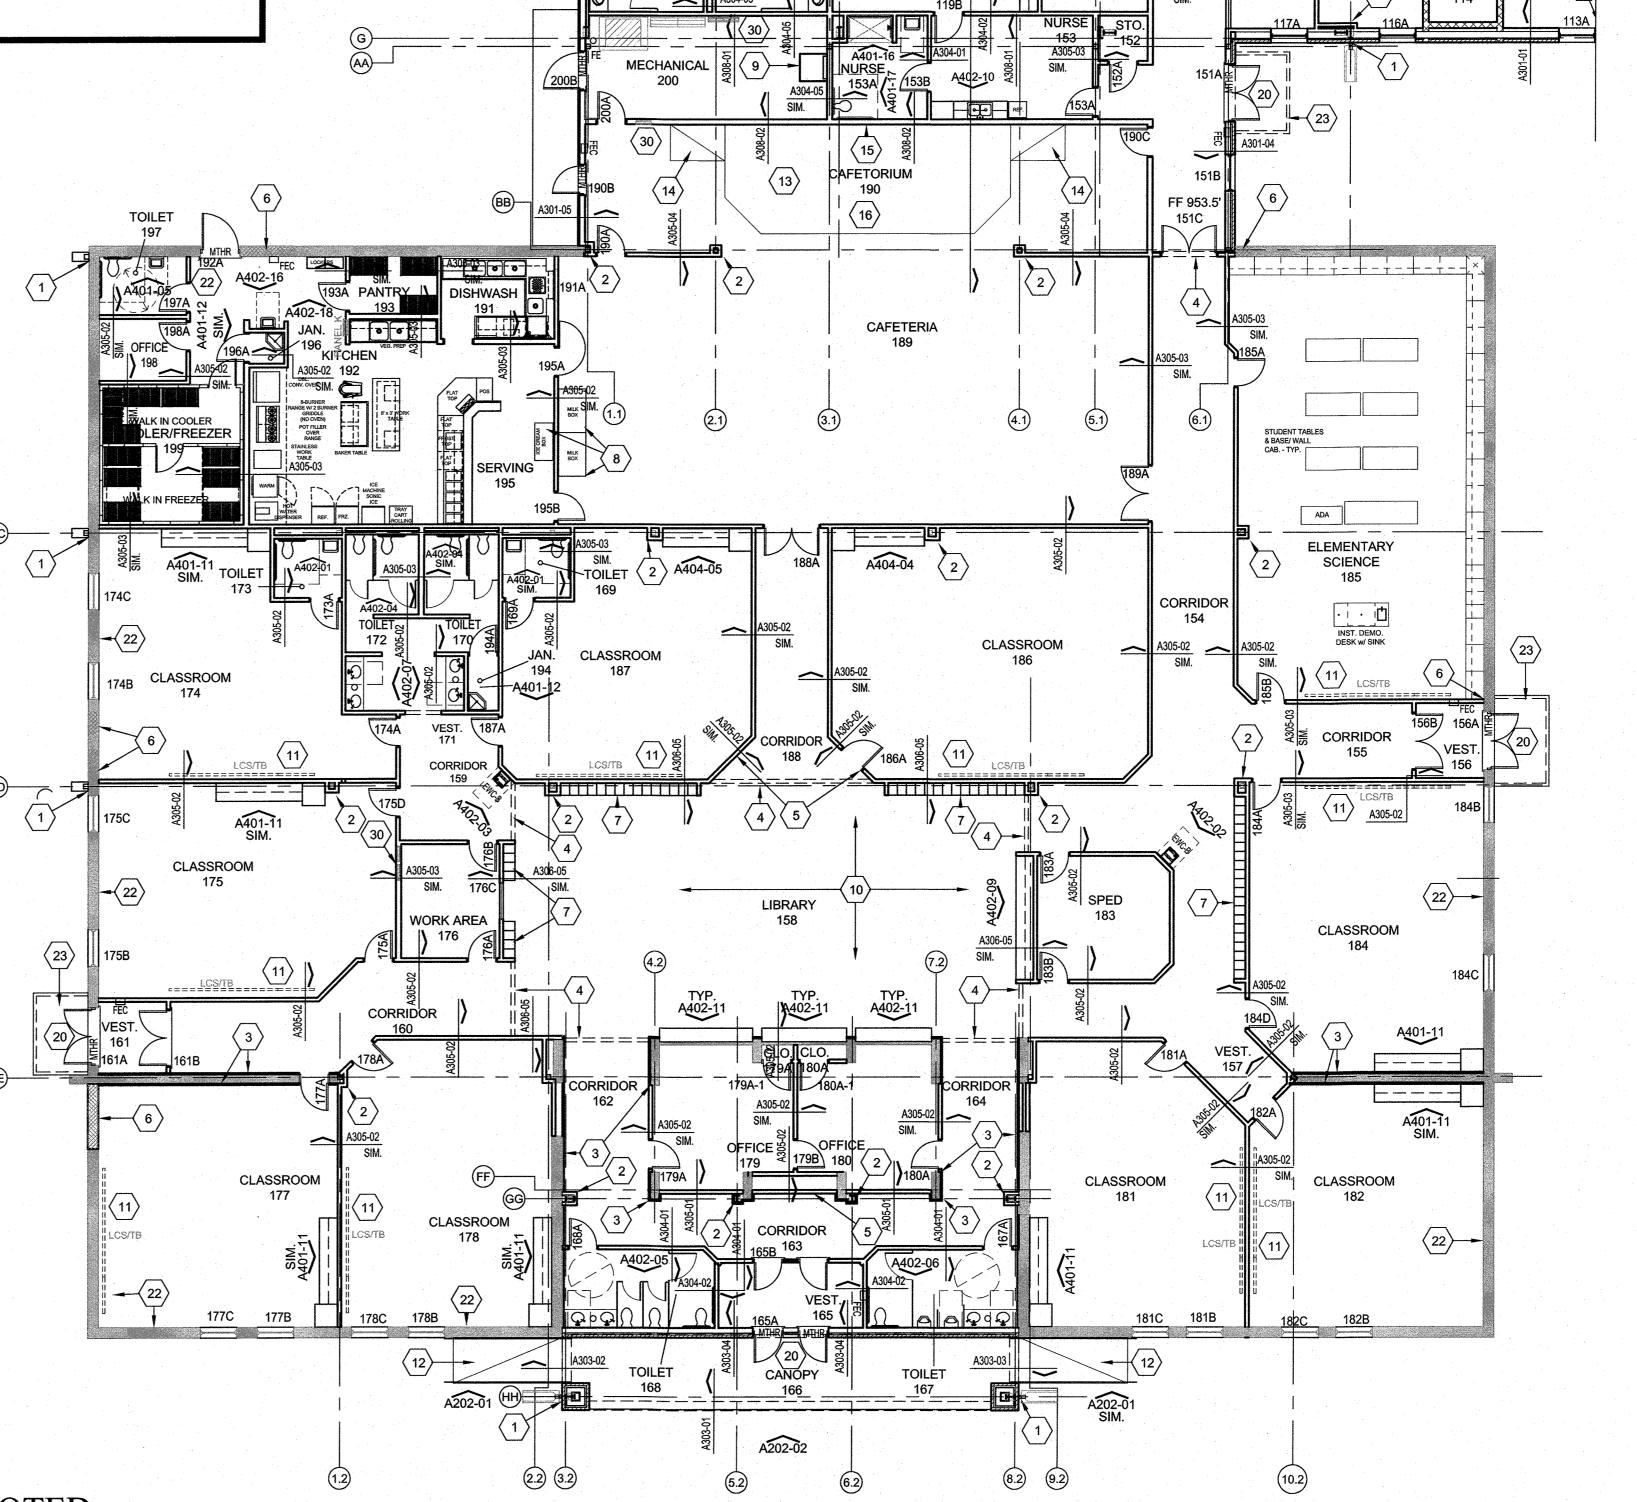
A501 FOR ADDITIONAL DETAILS. COORD. ELECTRICAL AS REQUIRED FOR PROVIDED


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- 30. APPROXIMATE LOCATION OF NEW ELECTRICAL PANELS COORD. LOCATION AND MOUNTING WITH CONSTRUCTION TYPE - REF. MEP FOR PANEL DETAILS.

FLOOR PLAN GENERAL NOTES


- REF. TO SEC. 099990 AND 099999 IN THE PROJECT MANUAL FOR THE "FINISH SCHEDULE" AND "FINISH SCHEDULE KEY".
- REF. THE DWGS. AND SEC. 012300 OF THE PROJ. MANUAL FOR MORE INFO. AND DESCRIPTIONS ON THE ALTERNATES FOR THIS PROJECT. REF. THE DRAWINGS AND SEC. 011000 OF THE PROJ. MANUAL FOR MORE
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- AT OPENINGS DOORS AND WINDOWS PROVIDE GYP. BD. EXP. JT. VERTICAL AT EACH CORNER - TO ABOVE CEILING - REF. PROJECT MAN. SEC.
- PROVIDE PAINT AS SPEC FOR ALL HM. FRAMES AND DOORS.

FLOOR PLAN LEGEND INTERIOR OPNG. KEY KEYNOTE ELEV. SYMBOL **CUT SYMBOL** $\left\langle 1\right\rangle$ - DETAIL NUMBER -OPNG. #- SHEET NUMBER — ⇒ 5'-0"Ø ALLOWABLE TURNING METAL THRESHOLD SPACE FOR DISABLED PERSONS ELECTRIC WATER COOLER 30"x48" CLEAR FLOOR SPACE FOR DISABLED PERSONS AT A ELECTRIC WATER COOLER LAVATORY W/ BOTTLE FILLER EXT. WALL - PEMB W/ EIFS & BRICK VENEER AND STUD INT. FIRE EXTINGUISHER EXT. WALL - PEMB W/ EXT. FIRE EXTINGUISHER MTL. PNL. AND STUD INT. IN FIRE EXTINGUISHER CAB. EXT. WALL - MTL. STD. W/ EXT. MTL. PNL AND GYP. BD. LIQUID CHALK SYSTEM EXT. WALL - MTL. STD. W/ EXT. MARKERBOARD AND EIFS & BRICK VENEER AND TACKBOARD COMBO GYP. BD. INT. 3 5/8" MTL. STD. W/ GYP. BD. 1 SIDE 6" MTL. STD. W/ GYP. BD. 2 SIDES DOWNSPOUT w/ RUBBER SPLASH BLOCK 3 5/8" MTL. STD. W/ GYP. BD. 2 SIDES EXISTING WALL TO REMAIN




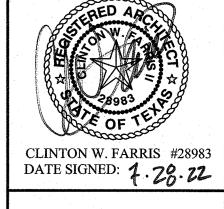



4724 OLD JACKSBORO HIGHWAY WICHITA FALLS, TEXAS 76302-3599 VOICE: 940.767.1421 FAX: 940.397.0273 WEB: www.hpa1962.com

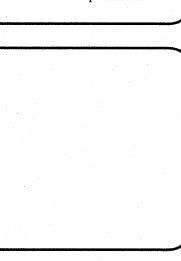

ADDITION

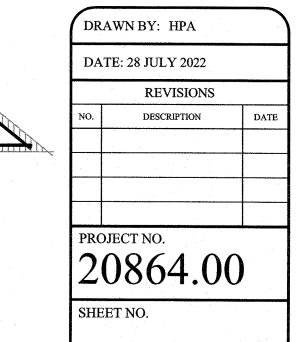

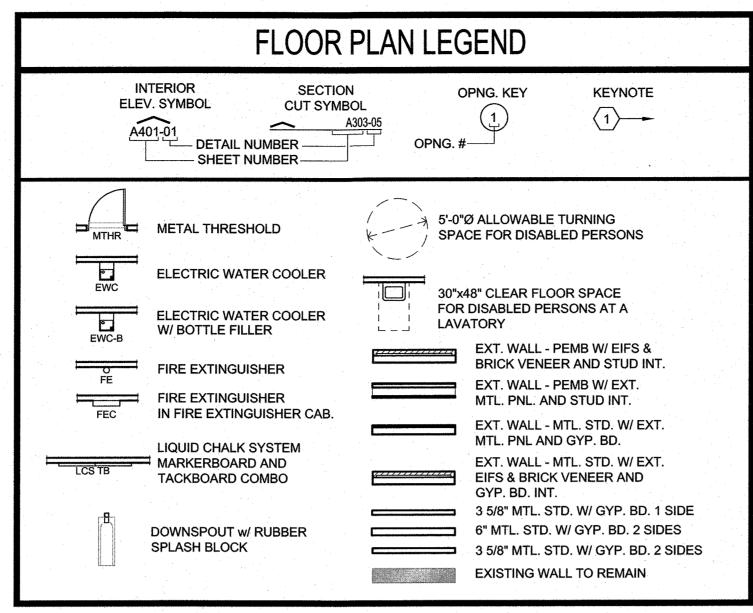

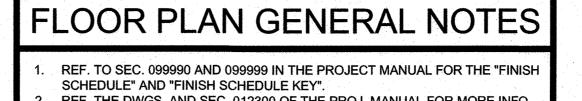

REF. THE DWGS. AND SEC. 012300 OF THE PROJ. MANUAL FOR MORE INFO.

AND DESCRIPTIONS ON THE ALTERNATES FOR THIS PROJECT.


REF. THE DRAWINGS AND SEC. 011000 OF THE PROJ. MANUAL FOR MORE

INFO. AND DESCRIPTIONS ON THE BID LINE ITEMS FOR THIS PROJECT. BASE BID IN ALL CORRIDORS IS TO PROVIDE A 6'-0" TALL CERAMIC TILE AS SPEC. WAINSCOT W/ GYP. BD. ABOVE. REF. ALTERNATES IN 012300 OF THE PROJECT MANUAL FOR DEDUCT ALTERNATE TO PROVIDE VANDAL

RESISTANT GYP. BD. IN LIEU OF CERAMIC TILE. AT OPENINGS - DOORS AND WINDOWS - PROVIDE GYP. BD. EXP. JT. VERTICAL AT EACH CORNER - TO ABOVE CEILING - REF. PROJECT MAN. SEC.

092116 FOR DETAILS. PROVIDE PAINT AS SPEC FOR ALL HM. FRAMES AND DOORS.

CLINTON W. FARRIS #28983 DATE SIGNED: $1 \cdot 28 \cdot 22$ 4724 OLD JACKSBORO HIGHWAY WICHITA FALLS, TEXAS 76302-3599 VOICE: 940.767.1421 FAX: 940.397.0273 WEB: www.hpa1962.com

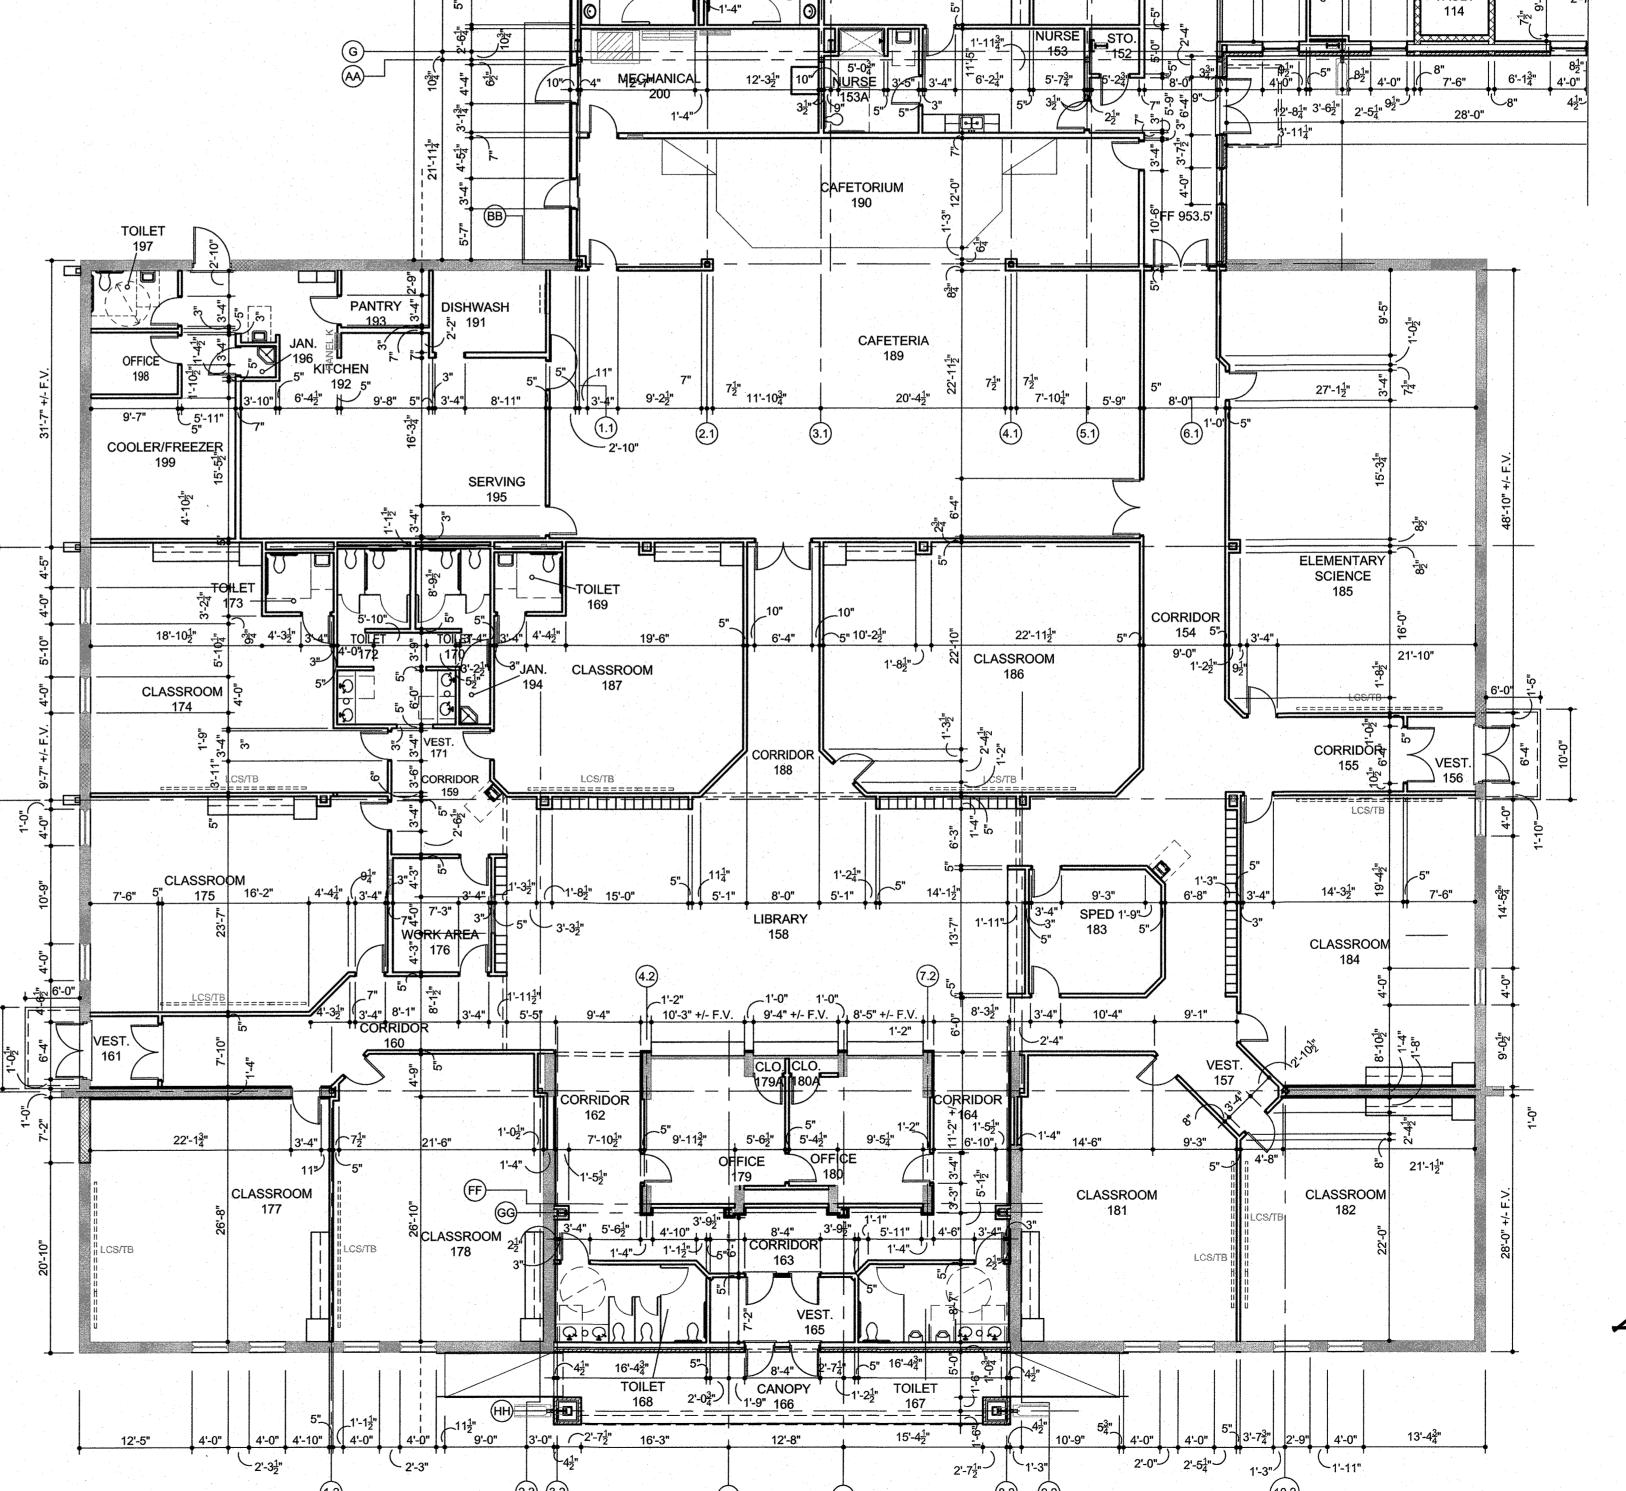

FLOOR PLAN - ELEMENTARY - DIMENSIONED

SCALE 3/32" = 1'-0"


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PROJECT NO. 20864.00

DRAWN BY: HPA

DATE: 28 JULY 2022

REVISIONS

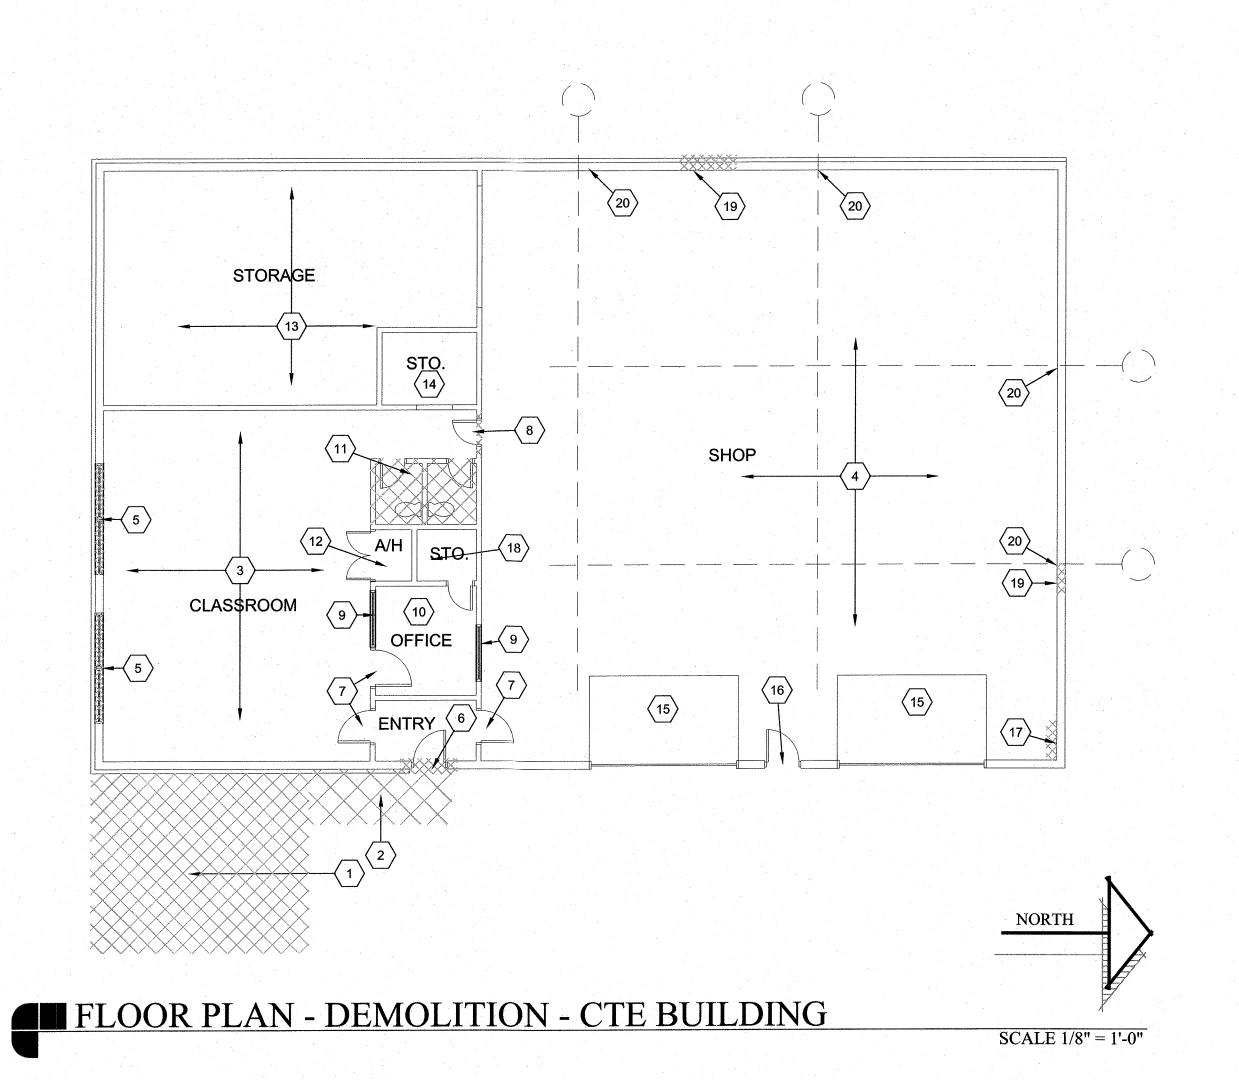


FLOOR PLAN KEYNOTES

- TOILET AREA SEE REF. CLG FOR DETAILS. PROVIDE NEW TEXTURE AND EXISTING DUCTWORK WILL REMAIN AND NEW CEILING GRILLES WILL SHALL
- THE EXISTING PEMB STRUCTURE EQ. TO EXTRUDECK SERIES ALUMINUM ALUMINUM CANOPY AS SPEC. FIELD VERIFY EXISTING PEMB STRUCTURE
- IN EXISTING SHOP AREA NEW ELECTRICAL AND MECHANICAL SYSTEMS WILL BE PROVIDED. REF. MEP SHEETS FOR DETAILS.


- COLUMN COORDINATE NEW COMPONENTS WITH EXISTING COLUMNS -

FLOOR PLAN GENERAL NOTES


- REF. THE DWGS. AND SEC. 012300 OF THE PROJ. MANUAL FOR MORE INFO
- RESISTANT GYP. BD. IN LIEU OF CERAMIC TILE.
- VERTICAL AT EACH CORNER TO ABOVE CEILING REF. PROJECT MAN. SEC

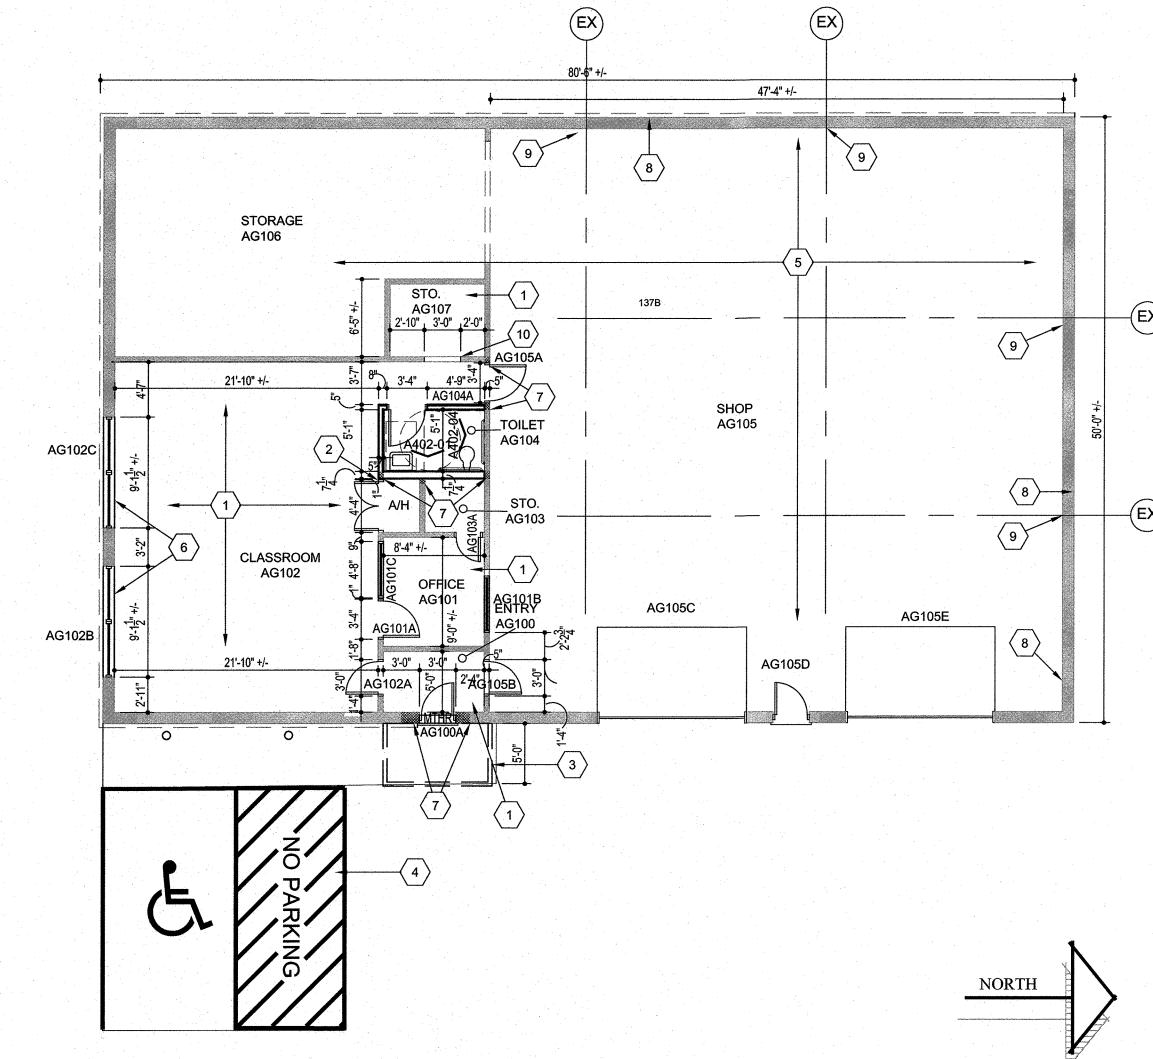


FLOOR PLAN - CTE BUILDING - NOTED AND DIMENSIONED

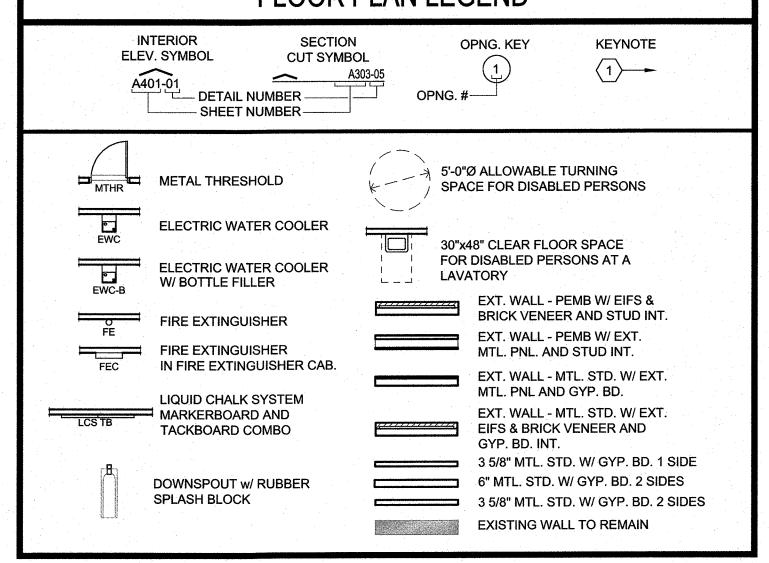

REFLECTED CEILING LEGEND

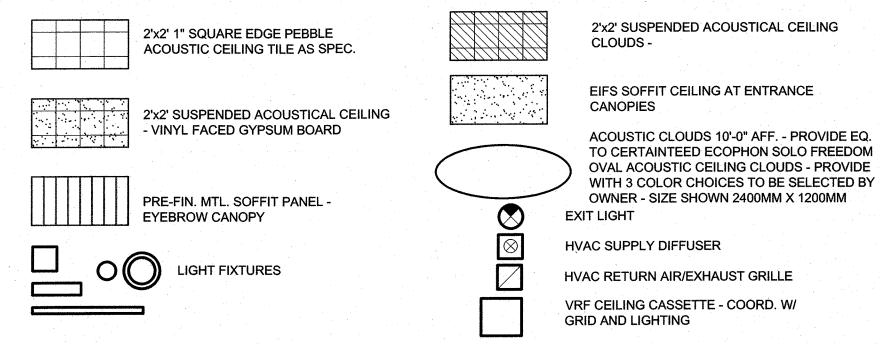

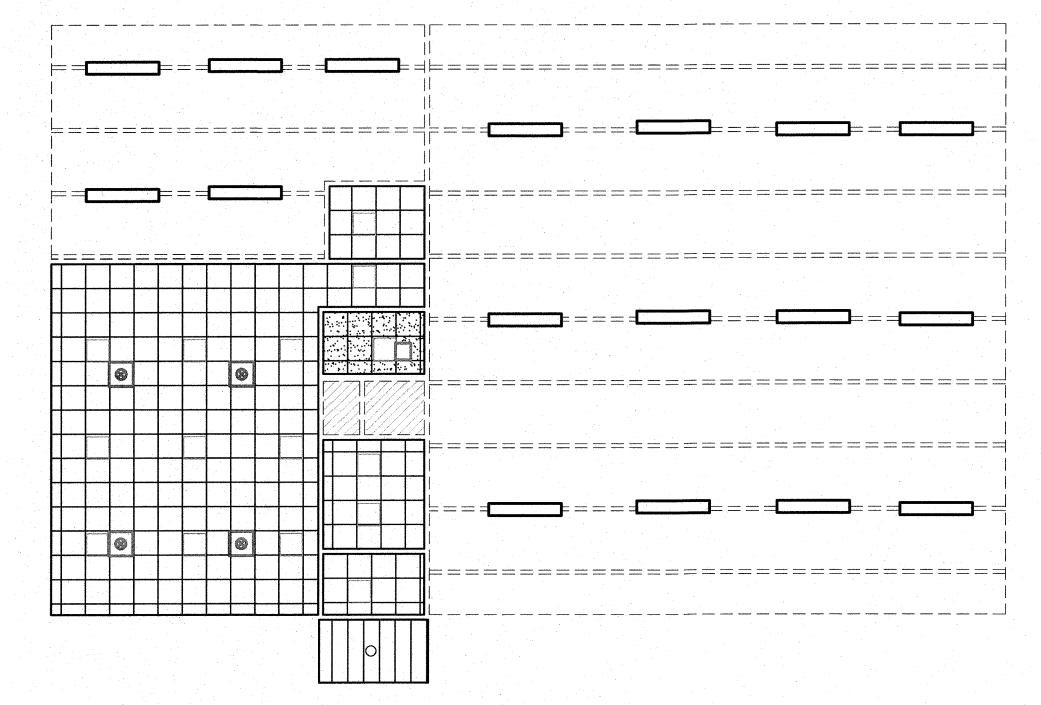

SCALE 1/8" = 1'-0"

DATE: 28 JULY 2022 REVISIONS DESCRIPTION

DRAWN BY: HPA

DATE SIGNED: 4.28.22

WICHITA FALLS, TEXAS 76302-3599

VOICE: 940.767.1421 FAX: 940.397.0273

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SHEET NO.

FLOOR PLAN LEGEND

GENERAL DEMOLITION NOTES

ARCHITECT AND ENGINEER HAVE EXHAUSTED EVERY EFFORT TO VERIFY EXISTING DIMENSIONS AND CONDITIONS. G.C. TO FIELD VERIFY EXISTING DIMENSIONS AND CONDITIONS AND NOTIFY ARCHITECT OF ANY VARIATIONS.

DEMOLITION KEYNOTES - CTE

EXISTING CHIP AND SEAL AND GRAVEL TO BE REMOVED AND PILED FOR FUTURE USE. PREPARE SUBGRADE FOR NEW

REMOVE EXISTING CONCRETE STOOP, GRAVEL AND CHIP AND SEAL WHERE NEW ACCESSIBLE WALKWAY WILL BE

PROVIDED. PILE GRAVEL AND CHIP AND SEAL FOR FUTURE USE AND HAUL CONCRETE OFFSITE. COORD. WITH NEW

IN EXISTING CLASSROOM, REMOVE EXISTING CEILINGS AND LIGHTING AND HAUL OFFSITE. REMOVE EXISTING HVAC GRILLES AND DIFFUSERS. NEW LIGHTING TO BE PROVIDED ON EXISTING CIRCUIT. EXISTING DUCTWORK SHALL

IN SHOP AREA, REMOVE EXISTING LIGHTING AND HAUL OFFSITE AND PREPARE FOR NEW LIGHTING TO BE INSTALLED.

REMOVE EXISTING WINDOWS IN EXISTING PEMB WALL AND HAUL OFFSITE. PREPARE EXISTING OPENING FOR NEW

REMOVE EXISTING HM. DR. AND FRAME AND HAUL OFFSITE. PREPARE OPENING FOR NEW DOOR AND FRAME WITH

EXISTING DOOR AND FRAME TO REMAIN AND WILL RECEIVE NEW HARDWARE AND PAINT. PROTECT FROM DAMAGE.

REMOVE EXISTING DOOR, FRAME AND SECTION OF WALL AS NECESSARY TO INSTALL NEW DOOR AND FRAME AS

IN EXISTING OFFICE AREA REMOVE EXISTING CEILING AND LIGHTING AND HAUL OFFSITE. PREPARE AREA FOR NEW

CEILING AND NEW LIGHTING AS SCHEDULED - REF. MEP FOR ADDITIONAL DETAILS. EXISTING MILLWORK, FLOORING

REMOVE EXISTING TOILET AREAS AND PREPARE FOR NEW SINGLE USER TOILET. REMOVE FIXTURES, WALLS, DOORS,

FRAMES AND ALL ASSOCIATED COMPONENTS AND HAUL OFFSITE. PREPARE AREA FOR NEW TOILET AREA AS

. IN EXISTING STORAGE AREA - REMOVE EXISTING CEILING AND LIGHTING AND PREPARE FOR NEW CEILING AND

6. EXISTING DOOR AND FRAME TO REMAIN AND TO RECEIVE NEW PAINT AND NEW TAS/ADA COMPLIANT HARDWARE.

9. REMOVE SECTION OF EXISTING PEMB WALL PANEL ABOVE GIRT TO INSTALL NEW MECHANICAL LOUVRE AS SCHEDULED. COORDINATE DIMENSIONS OF WALL REMOVAL WITH NEW LOUVRE TO BE PROVIDED. MAINTAIN A

EXISTING AIR HANDLER AND ASSOCIATED COMPONENTS IN CLOSET TO REMAIN AND BE REUSED. PROTECT FROM

WINDOWS TO BE PROVIDED - KEEP BUILDING WEATHERTIGHT AT ALL TIMES. REF. PLAN FOR DETAILS.

EXISTING INTERIOR WINDOW AND FRAME TO REMAIN. FRAMES TO BE PAINTED - PROTECT FROM DAMAGE.

3. IN EXISTING STORAGE AREA - ONLY NEW LIGHTING TO BE PROVIDED - REF. MEP FOR DETAILS.

7. EXISTING DISTRIBUTION PANEL TO BE REMOVED AND RELOCATED - REF. MEP FOR DETAILS.

20. EXISTING 2 POLE RECEPTACLE TO BE REMOVED AND RELOCATED - REF. MEP FOR DETAILS.

NEW LIGHT FIXTURE AND SWITCH IN THIS AREA ONLY - NO OTHER WORK TO OCCUR.

LIGHTING. FLOORS AND WALLS WILL REMAIN AND FINISH AS SCHEDULED. REF. PLANS FOR DETAILS.

REMAIN. FLOORING AND WALL TEXTURE SHALL REMAIN - PROTECT FROM DAMAGE. REF. MEP FOR ADDITIONAL

HANDICAP ACCESSIBLE PARKING AREA - REF. CIVIL FOR DETAILS.

FLATWORK - REF. CIVIL FOR ADDITIONAL DETAILS.

ACCESS CONTROL HARDWARE. REF. PLAN FOR DETAILS.

AND WALLS WILL REMAIN - PROTECT FROM DAMAGE.

NECESSARY. REF.MEP FOR ADDITIONAL DETAILS.

5. EXISTING OVERHEAD DOORS TO REMAIN - PROTECT FROM DAMAGE.

SCHEDULED. REF. PLANS FOR DETAILS.

WEATHERTIGHT BUILDING AT ALL TIMES.

REF. MEP FOR DETAILS.

DAMAGE.

- DEMOLITION WORK INVOLVING MECHANICAL, PLUMBING, AND ELECTRICAL ITEMS OCCURS IN VARIOUS AREAS. REFER TO MECHANICAL, PLUMBING, AND ELECTRICAL DEMOLITION PLANS FOR
- REF. TO CIVIL SHEETS FOR ADDITIONAL DEMOLITION ITEMS RELATED TO EXISTING SITE ELEMENTS.

DESIGNATED AREA - REF. CIVIL FOR DETAILS.

FLASHING AS DETAILED. PROVIDE NEW GYP. BD. AT EXISTING JAMB AND

DETAILS.


FIELD VERIFY EXISTING CONDITIONS PRIOR TO PROPOSAL

SCHEDULE" AND "FINISH SCHEDULE KEY".

AT OPENINGS - DOORS AND WINDOWS - PROVIDE GYP. BD. EXP. JT.

PROVIDE PAINT AS SPEC FOR ALL HM. FRAMES AND DOORS.

REFLECTED CEILING PLAN - CTE BUILDING

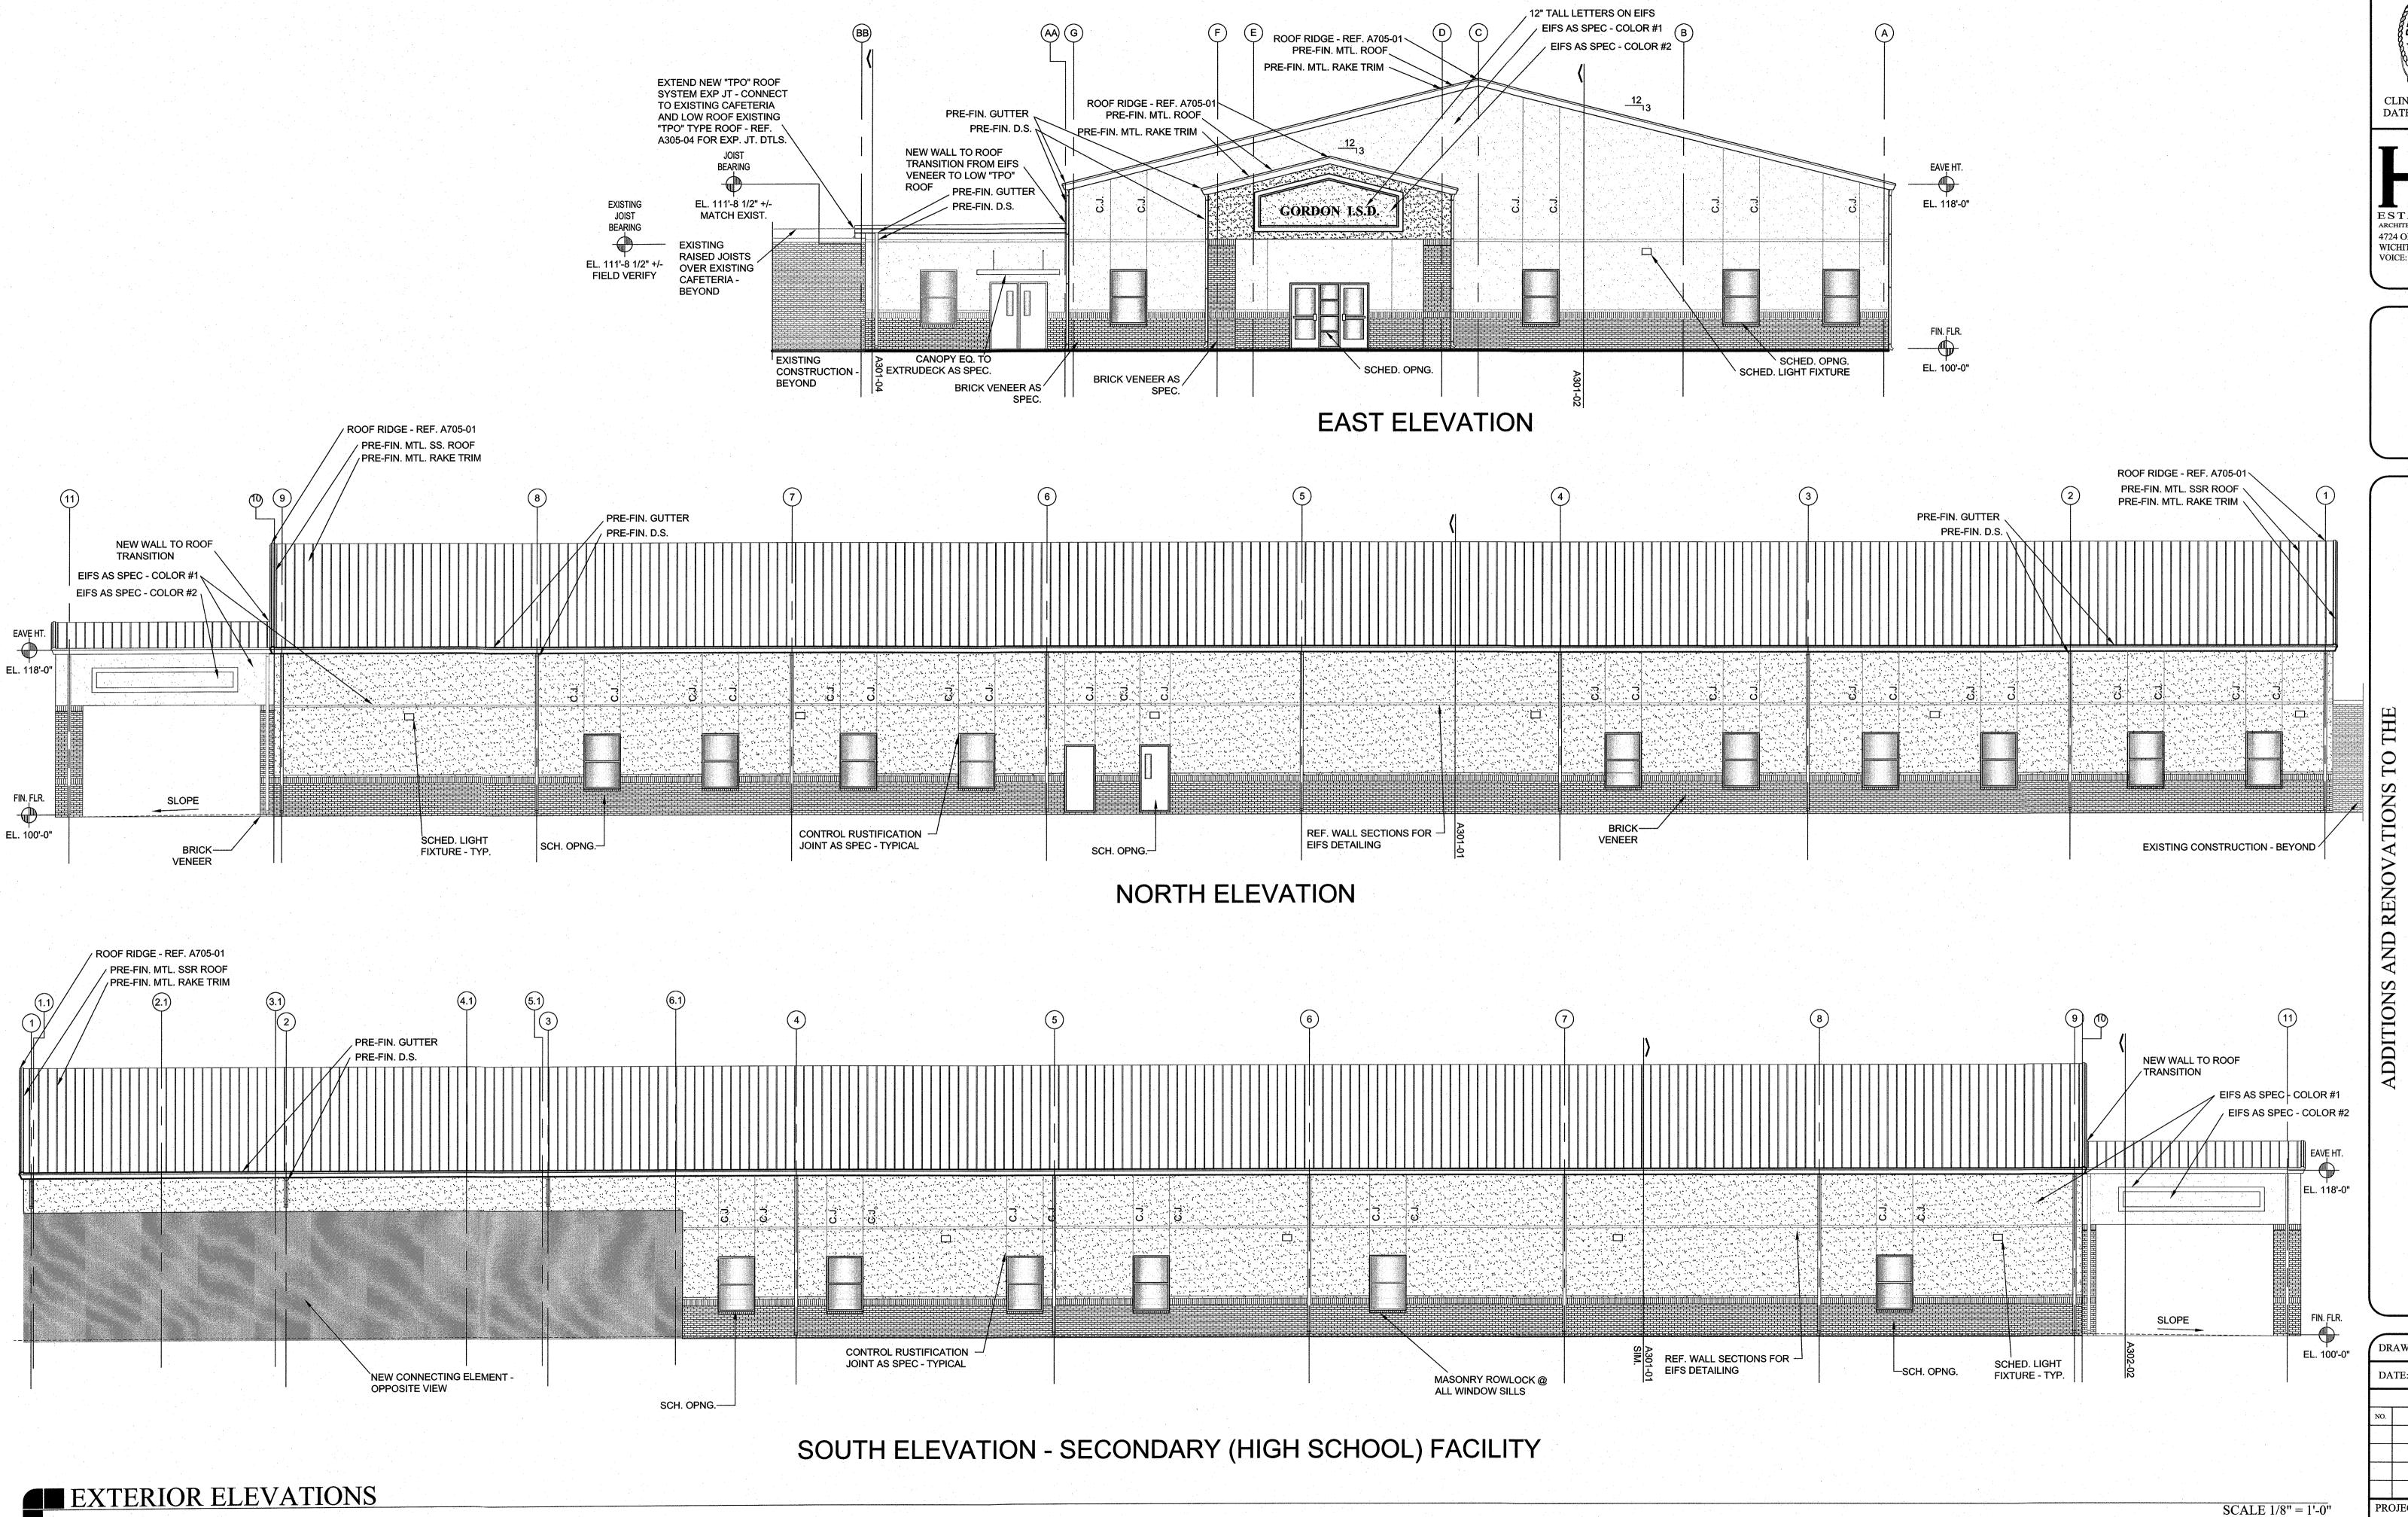

CLINTON W. FARRIS #28983
DATE SIGNED: 1.28.72

ESTABLISHED 1962
ARCHITECTS PROGRAMMERS PLANNERS
4724 OLD JACKSBORO HIGHWAY
WICHITA FALLS, TEXAS 76302-3599
VOICE: 940.767.1421 FAX: 940.397.0273
WEB: www.hpa1962.com

N I.S.D. CAMPUS GORDON I.S.D.

DRAWN BY: HPA


DATE: 28 JULY 2022

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PROJECT NO. 20864.00

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CLINTON W. FARRIS #28983
DATE SIGNED: 4.73.22

ESTABLISHED 1962
ARCHITECTS · PROGRAMMERS · PLANNERS
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VOICE: 940.767.1421 FAX: 940.397.0273 WEB: www.hpa1962.com

DON I.S.D. CAMPUS
FOR GORDON I.S.D.

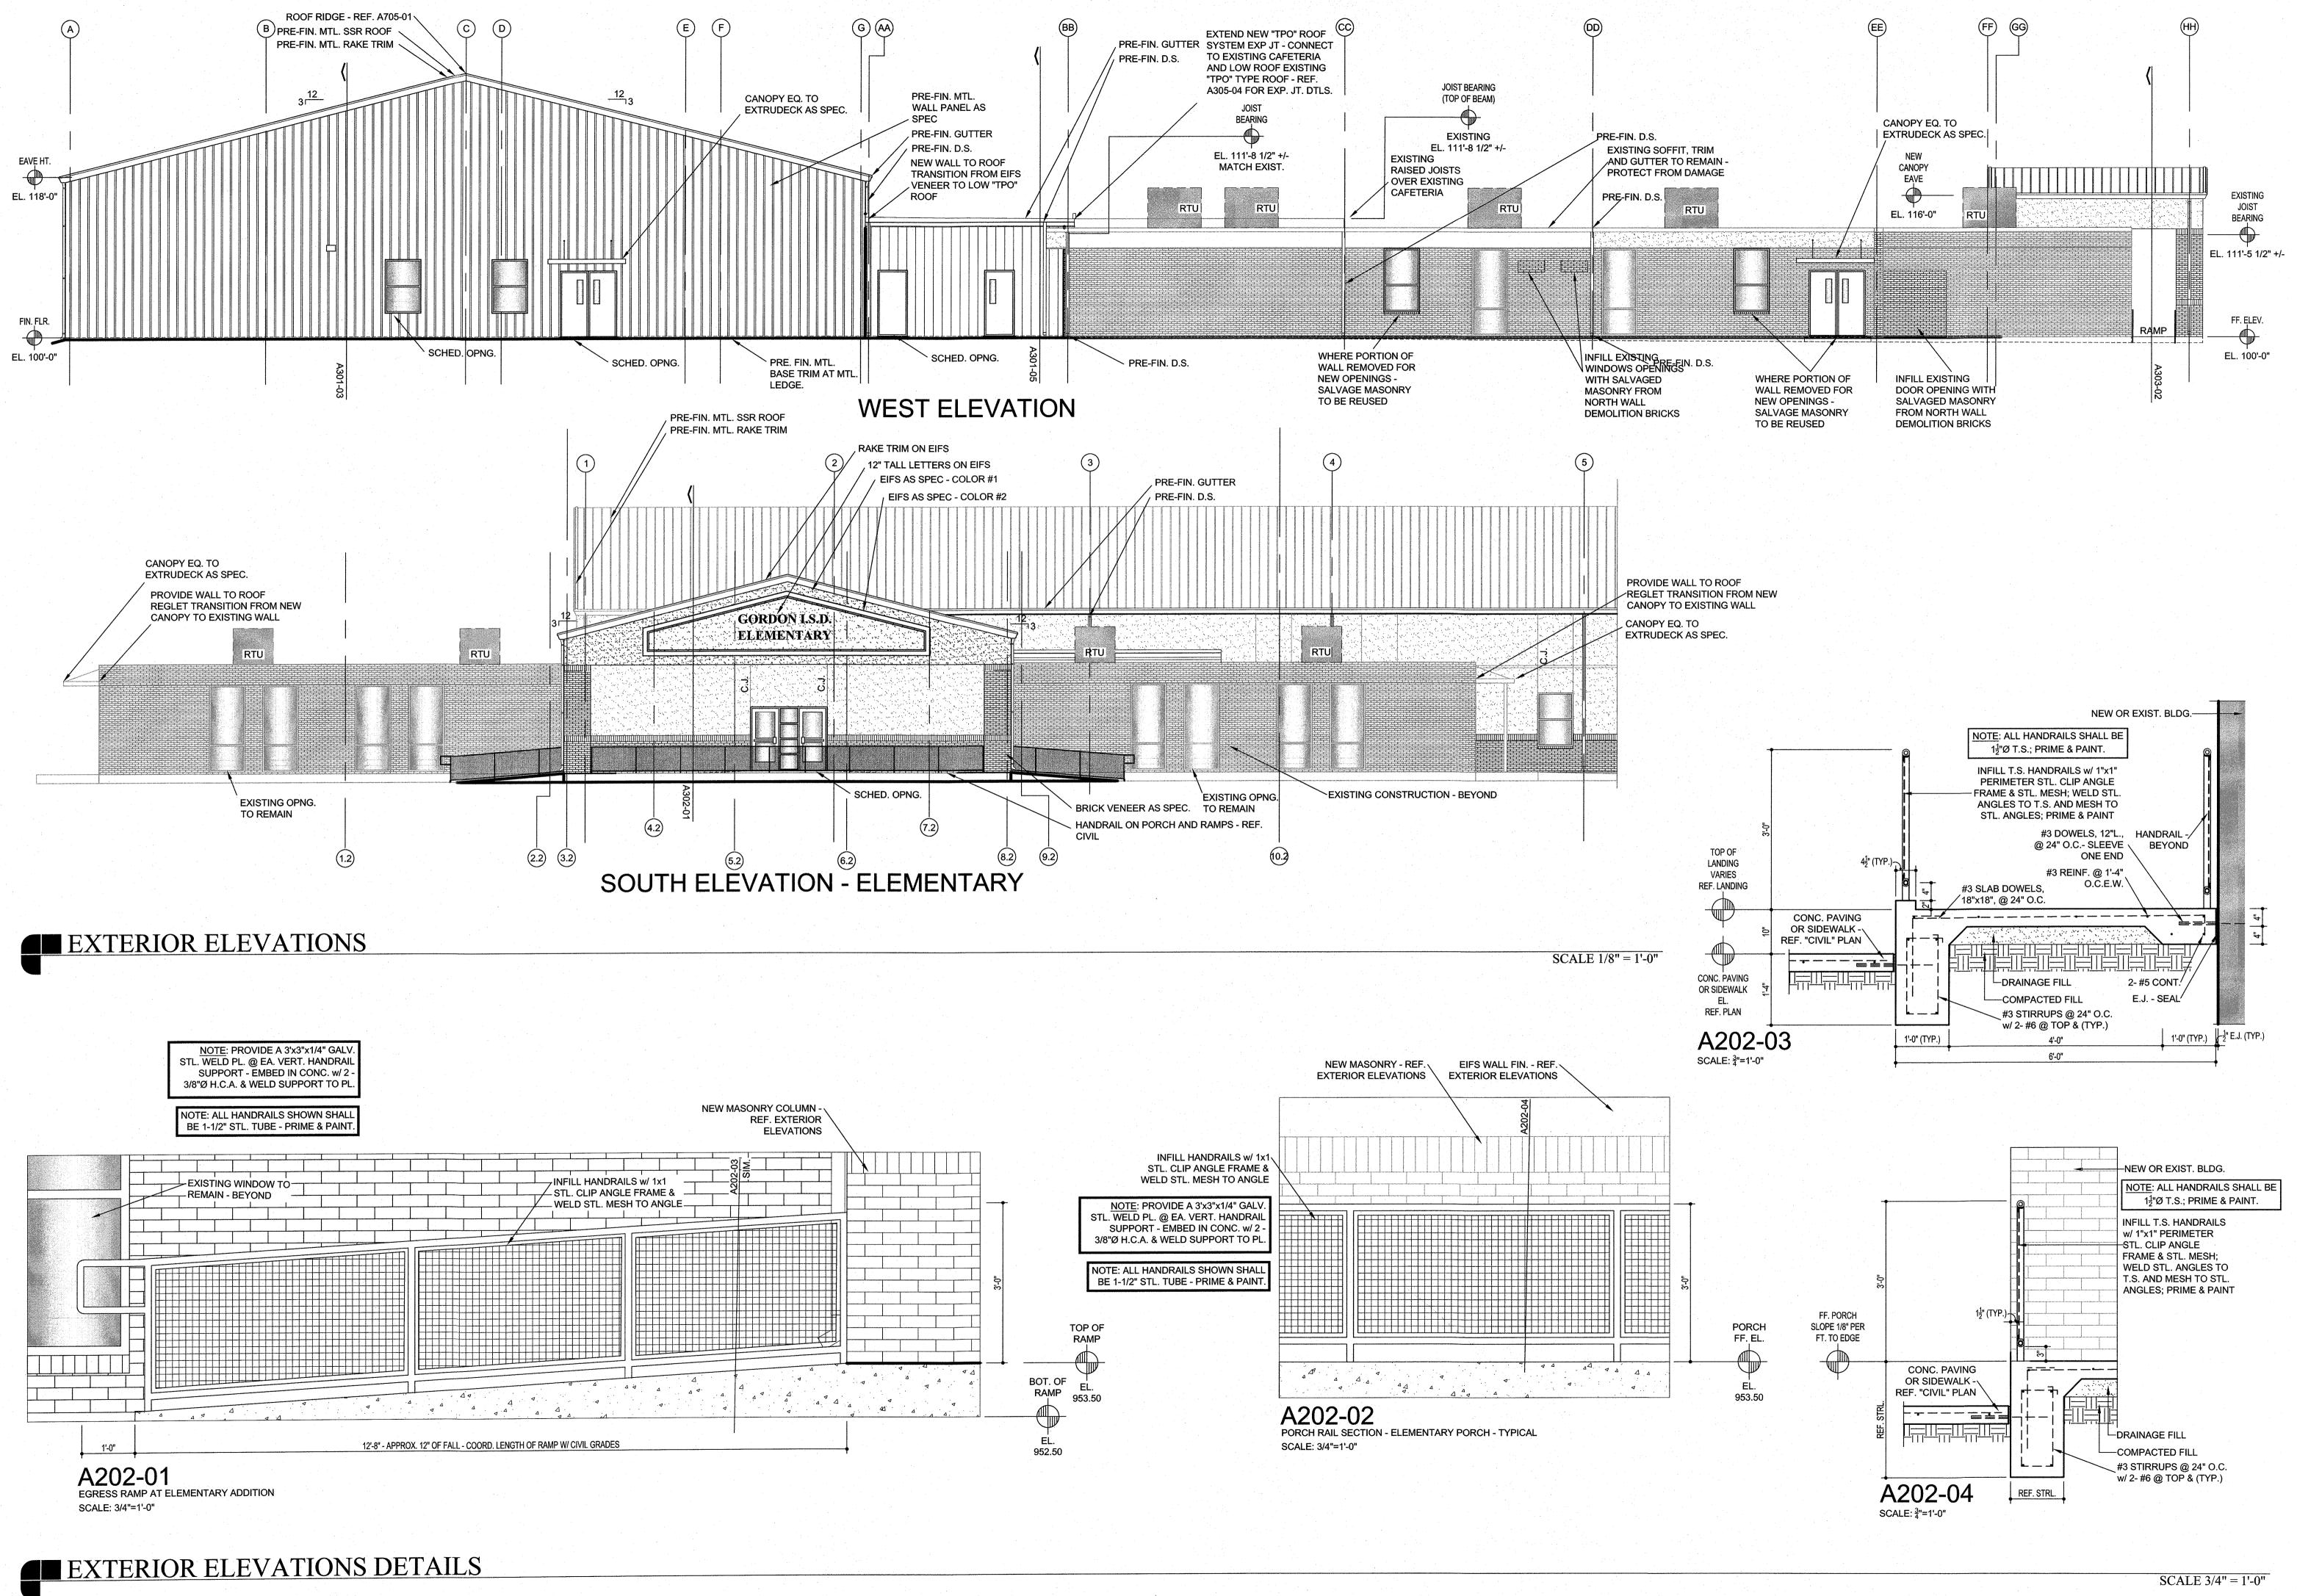DRAWN BY: HPA

DATE: 28 JULY 2022


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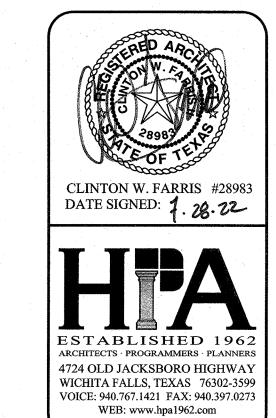
NO. DESCRIPTION DATE

PROJECT NO.

20864.00

SHEET NO.



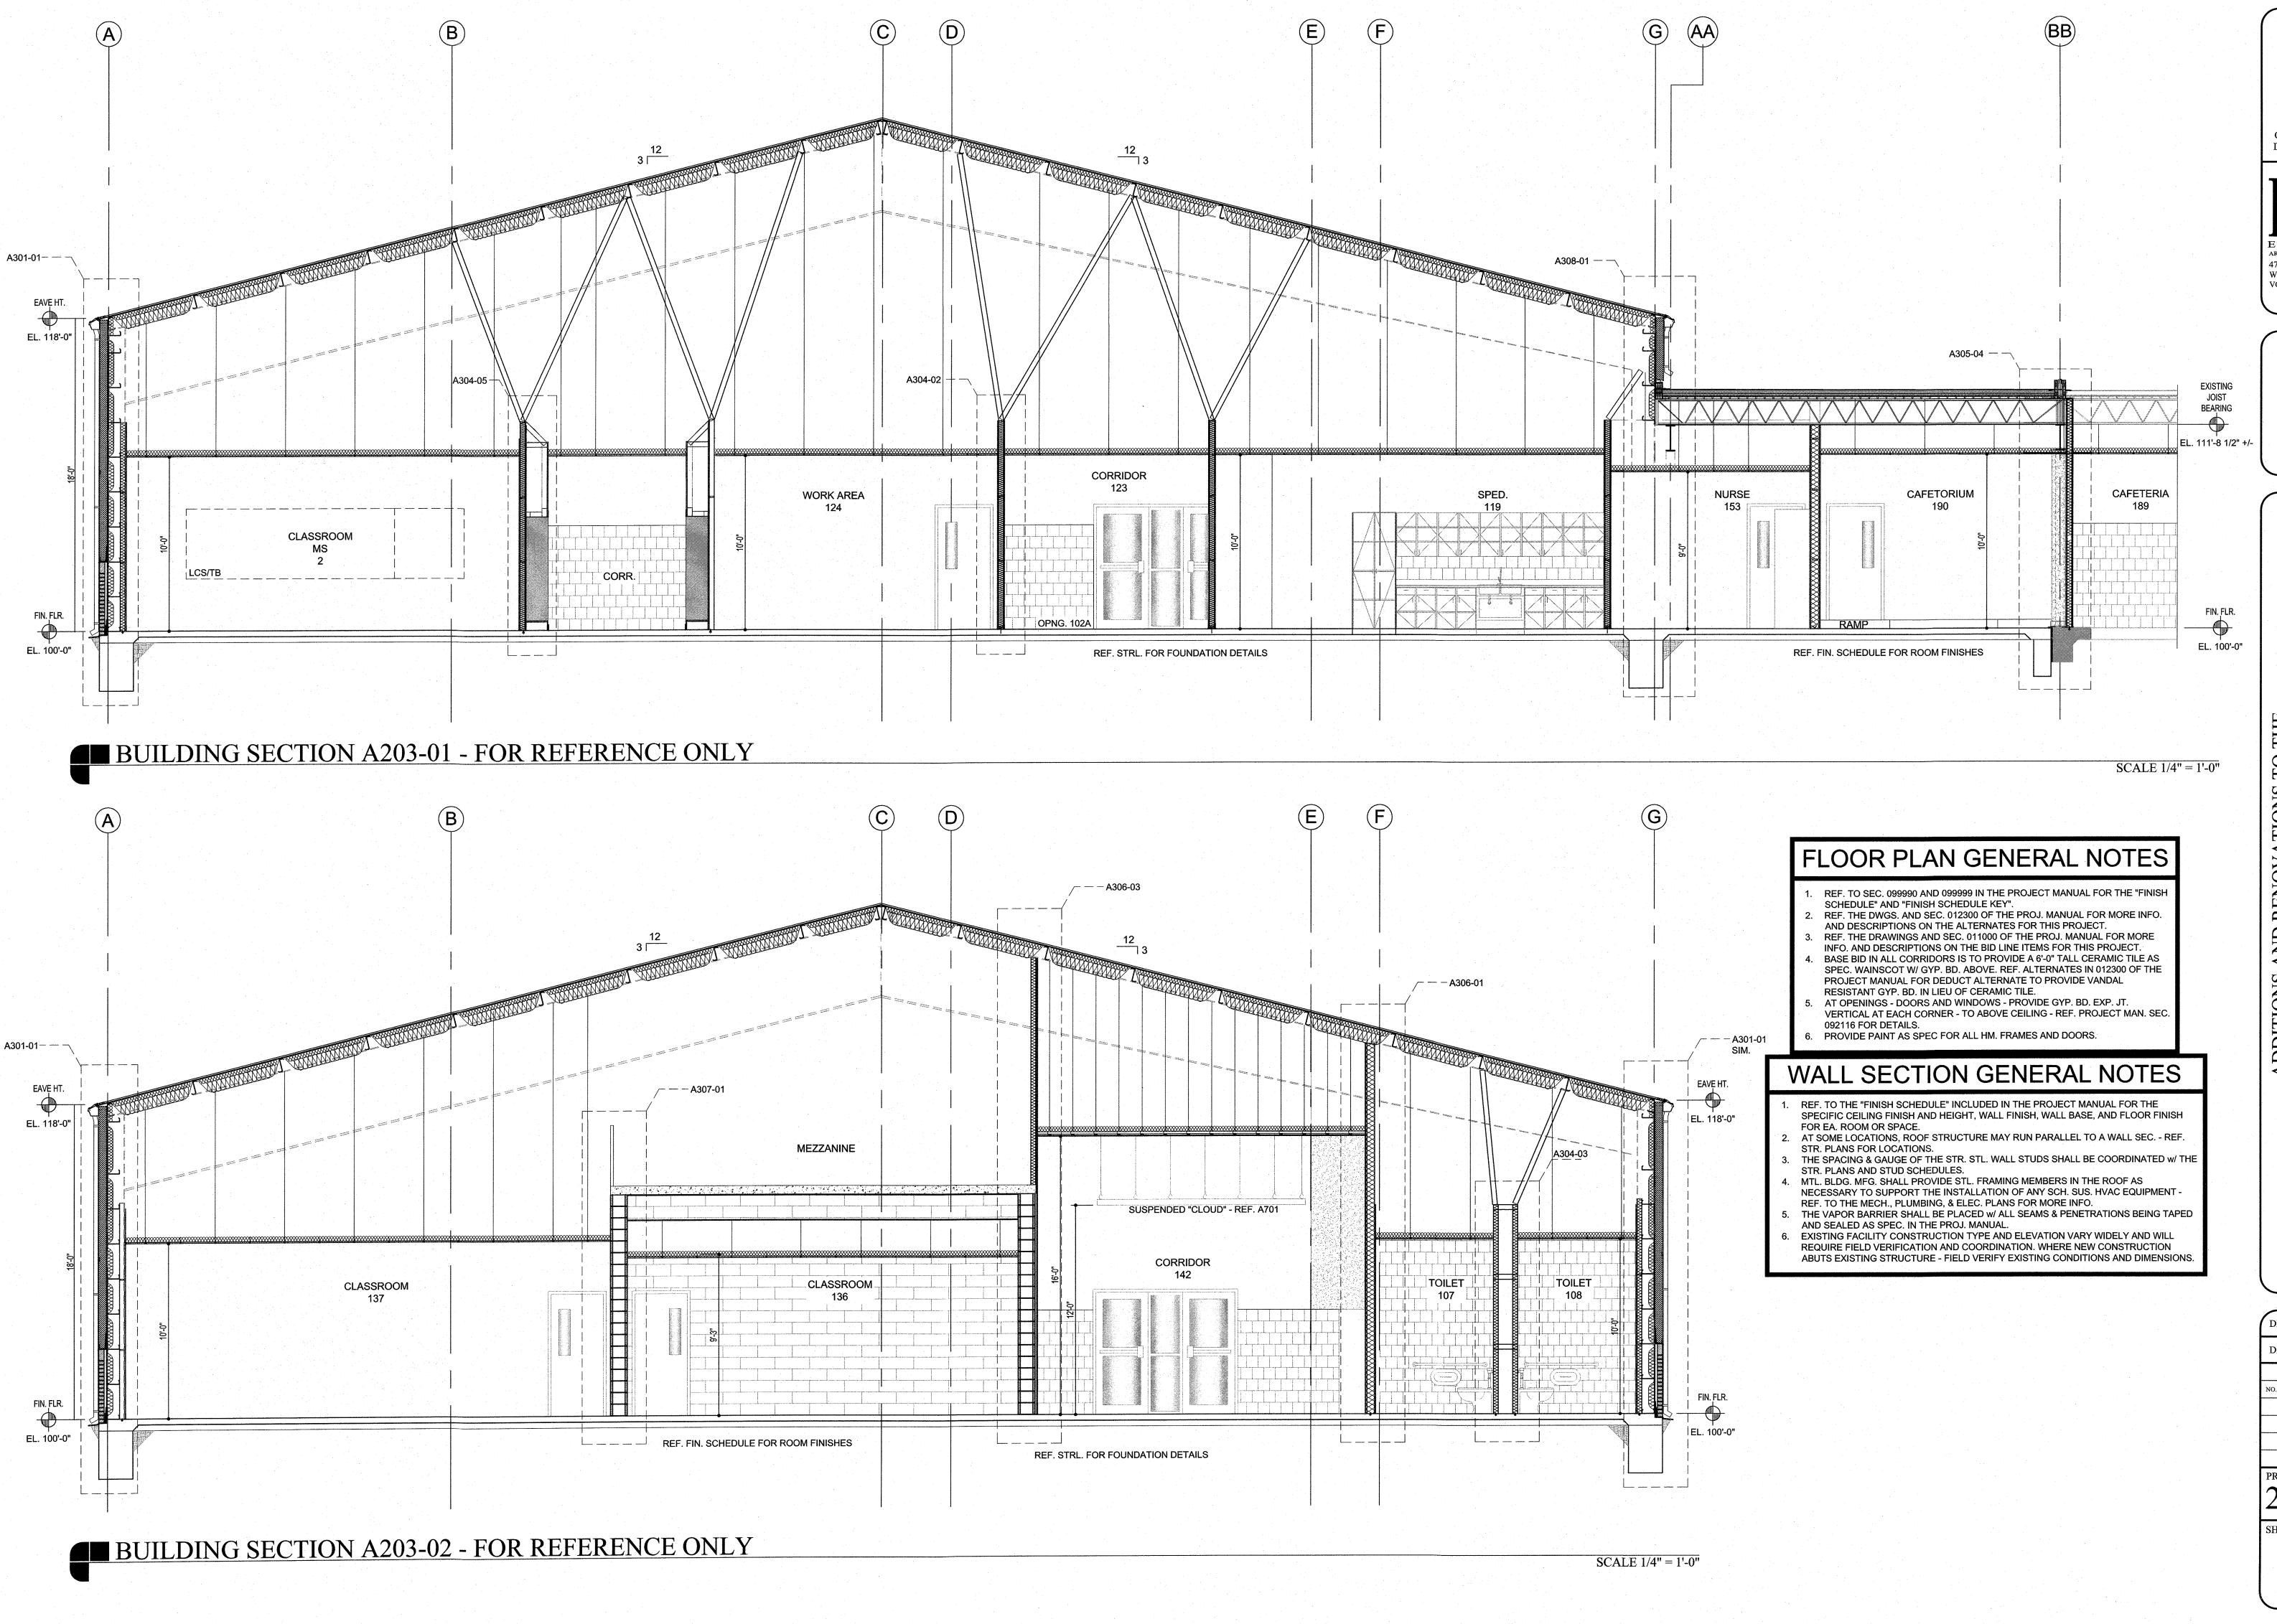

ON I.S.D. CAMPUS OR GORDON I.S.D.

DRAWN BY: HPA

DATE: 28 JULY 2022

REVISIONS

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PROJECT NO.

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