



ARCHITECTURAL PHASING PLAN.

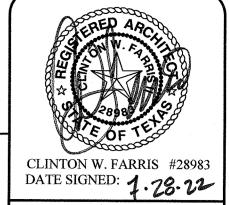







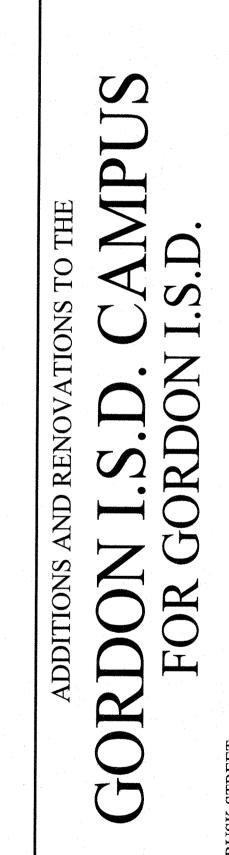

DRAWN BY: FINCHER

DATE: 28 JULY 2022

REVISIONS


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PROJECT NO. 20864.00


SHEET NO.

PD101



FLOOR PLAN - SOUTH - PLUMBING DEMOLITION

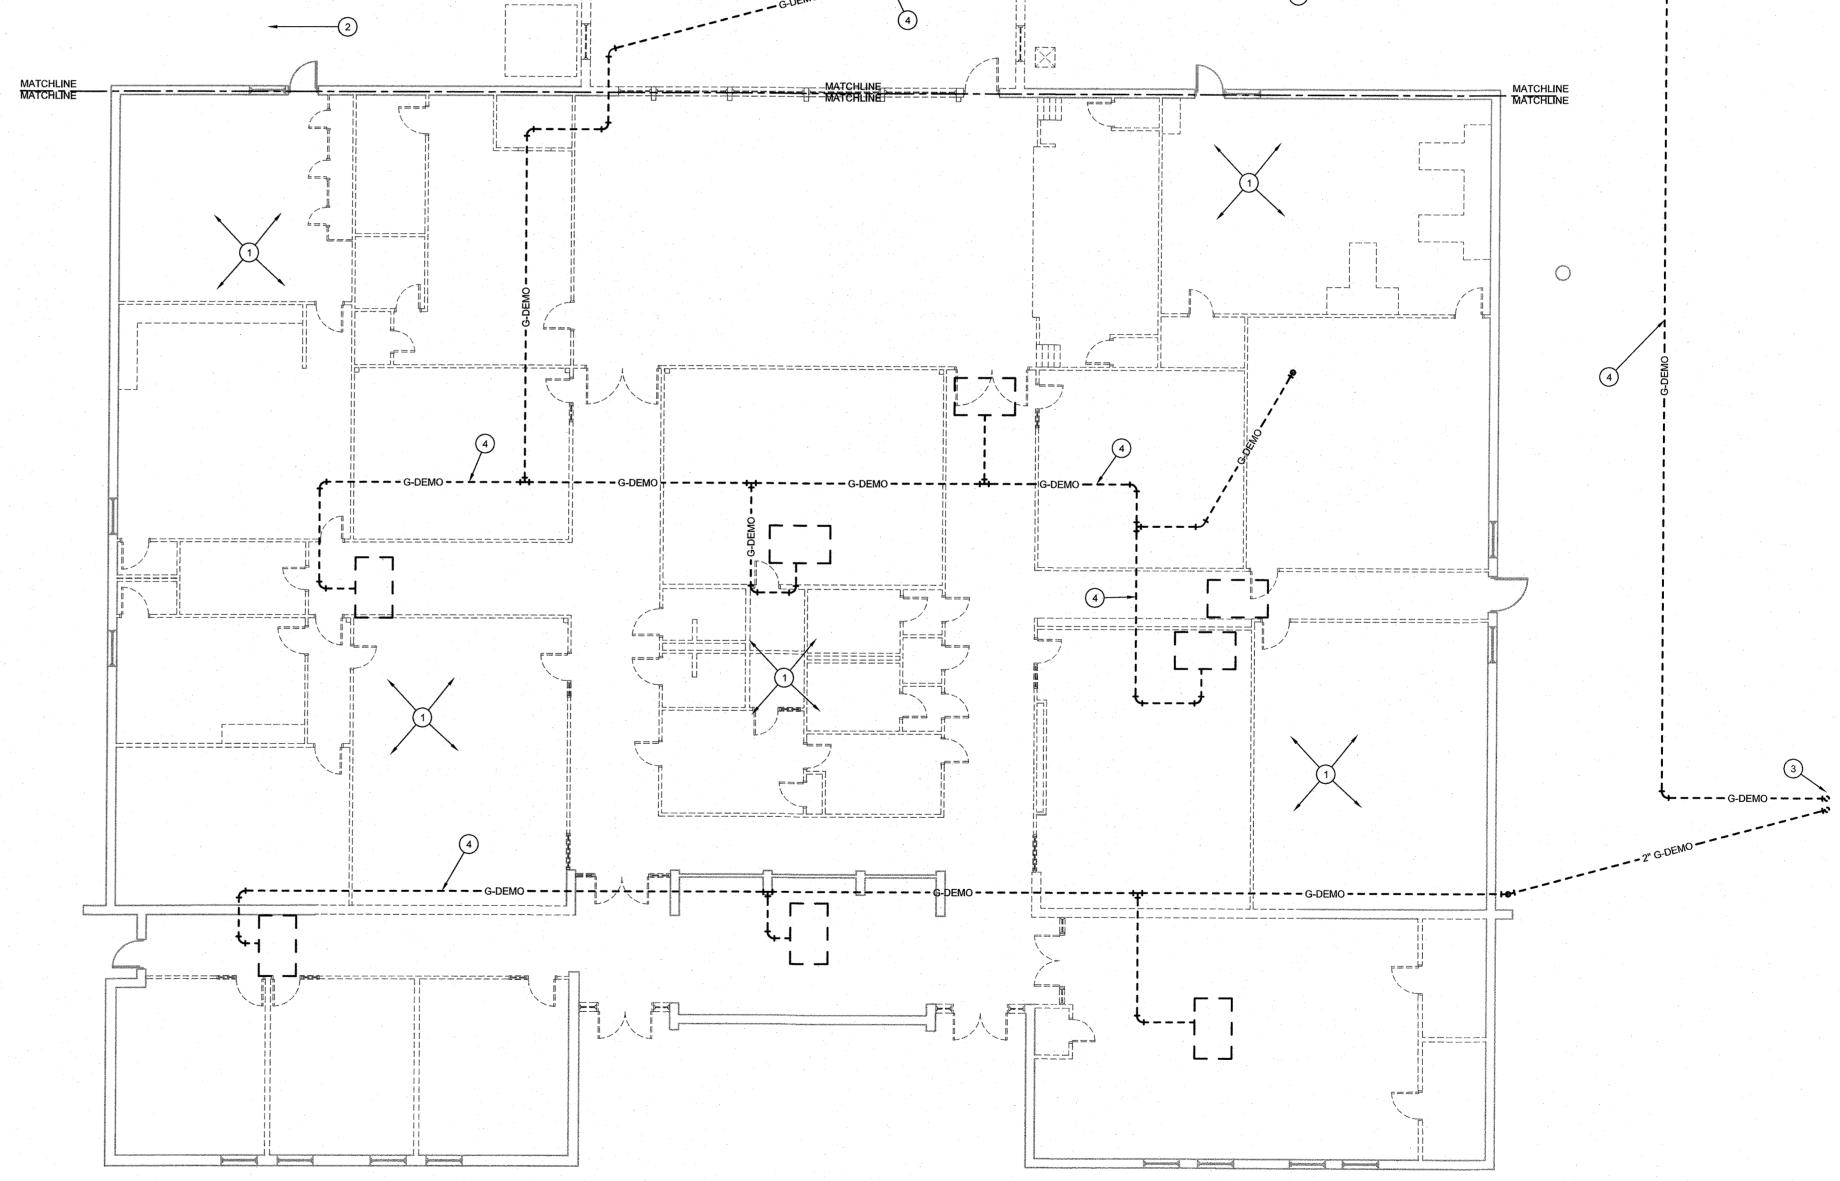SCALE: 3/32" = 1'-0"

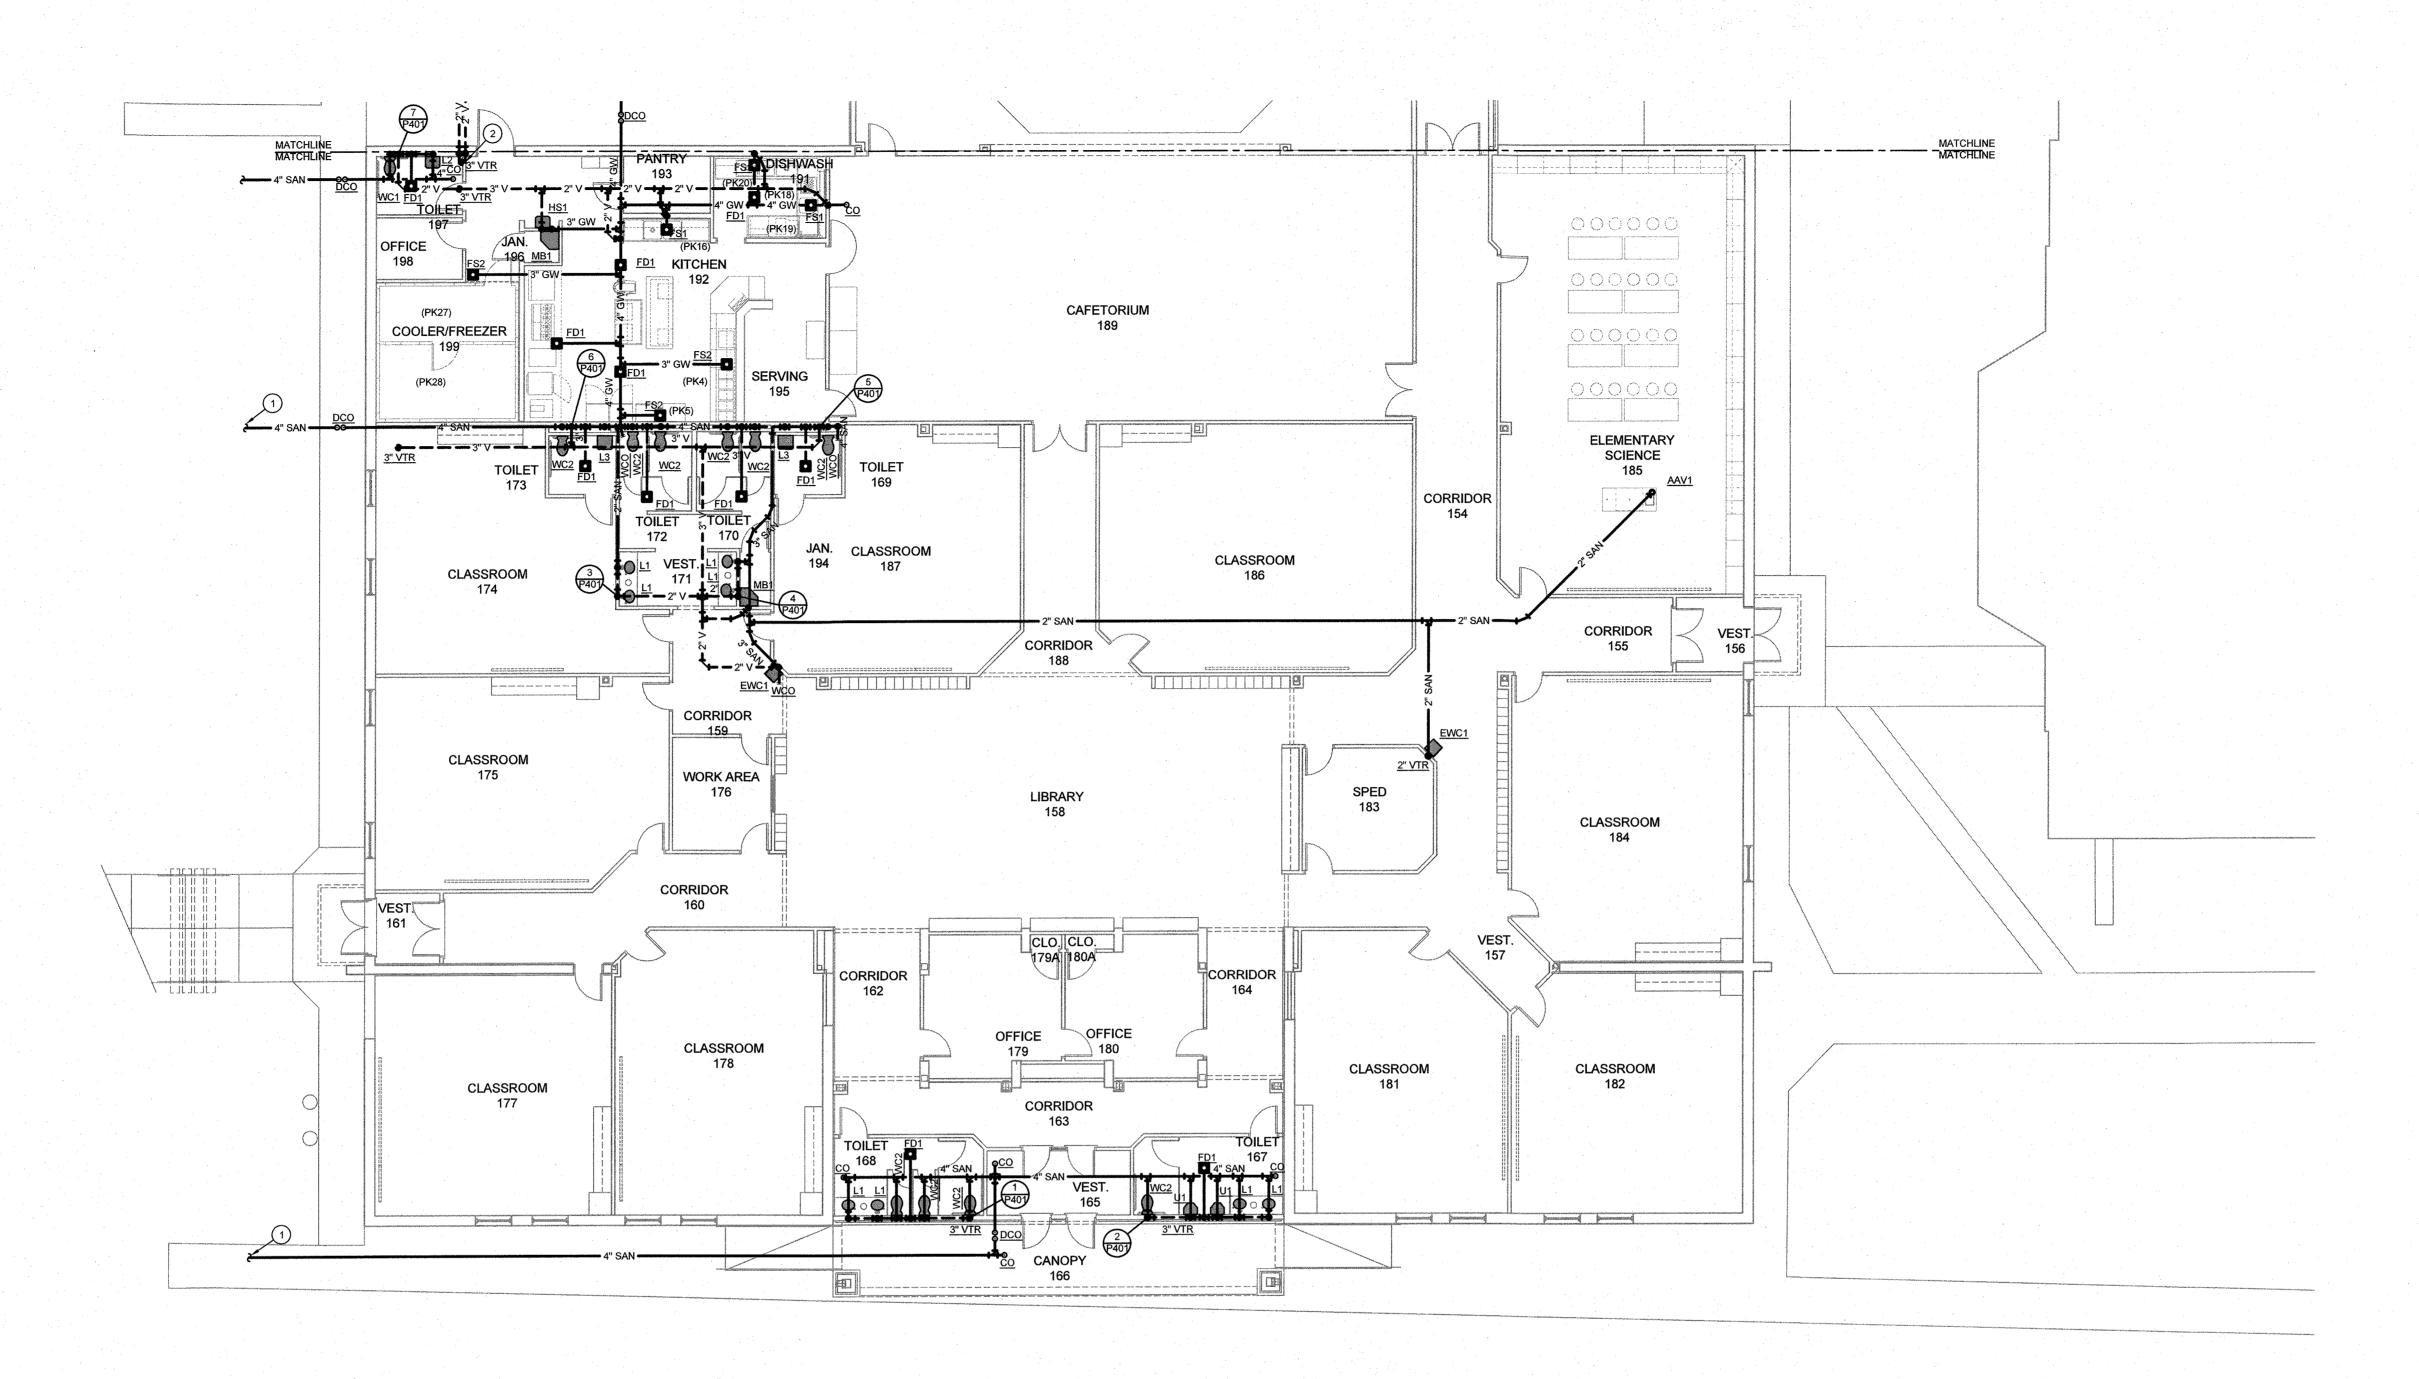




SCALE: 3/32" = 1'-0"

	GENERAL NOTES	O KEYED NOTES (
A. B.	ALL WORK SHALL COMPLY WITH ALL LOCAL AND STATE CODES AND AUTHORITIES HAVING JURISDICTION. VERIFY EXACT LOCATION OF ALL UTILITIES AND PIPING AT THE JOBSITE. CONTRACTOR SHALL VERIFY EXACT PLUMBING SYSTEMS PRIOR TO BID.	REFER TO CIVIL FOR CONTINUATION OF 4" SEWER LINE ON SITE. TWO 2" VENT LINES FROM GREASE TRAP. TURN VENT LINES UP SEPARATELY TO ABOVE CEILING THEN COMBINE INTO SINGLE 3" VENT THRU ROOF.
C.	CONTRACTOR SHALL COORDINATE ALL PLUMBING DISCONNECTIONS AND INTERRUPTIONS WITH BUILDING OWNER. VERIFY EXACT SCHEDULE WITH ARCHITECT AND OWNER.	
D.	CONTRACTOR SHALL COORDINATE EXACT LOCATIONS OF ALL VTR's WITH CONDITIONS AT JOBSITE. NO VTR SHALL BE INSTALLED WITH IN 15' OF ANY OUTSIDE AIR INTAKE.	
E.	MOUNTING HEIGHT OF ALL PLUMBING FIXTURES SHALL BE COORDINATED WITH ARCHITECT PRIOR TO INSTALLATION.	
F.	REFER TO PLUMBING KITCHEN EQUIPMENT SCHEDULE ON SHEET P501 FOR ALL CONNECTION REQUIREMENTS (PK#'S) AND RUNOUT SIZES.	
G.	CONTRACTOR SHALL TAKE CARE TO PROTECT ALL OPERATIONAL SYSTEMS. ANY EXISTING SYSTEMS THAT ARE DAMAGED DURING CONSTRUCTION SHALL BE REPAIRED OR REPLACED AT THE EXPENSE OF THE CONTRACTOR.	
H.	REFER TO PLUMBING FIXTURE CONNECTION SCHEDULE FOR RUNOUT LINE SIZES TO INDIVIDUAL FIXTURES WHERE LINE SIZES ARE NOT INDICATED ON FLOOR PLAN.	
I.	SAWCUT EXISTING FLOOR SLAB AS REQUIRED TO INSTALL ALL NEW BELOW SLAB SEWER AND WASTE LINES. PATCH AND REPAIR SLAB AS DIRECTED BY ARCHITECT.	
J.	CONTRACTOR SHALL COORDINATE ALL PLUMBING DISCONNECTIONS AND INTERRUPTIONS WITH BUILDING OWNER. VERIFY EXACT SCHEDULE AND PHASING WITH ARCHITECT AND OWNER. REFER TO ARCHITECTURAL PHASING PLAN.	
K.	BACK-TO-BACK WATER CLOSETS SHALL NOT BE PLUMBED USING TEE/CROSS FITTING AND EACH WATER CLOSET SHALL CONNECT TO SEWER LINE SEPARATELY,	



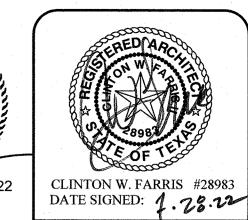





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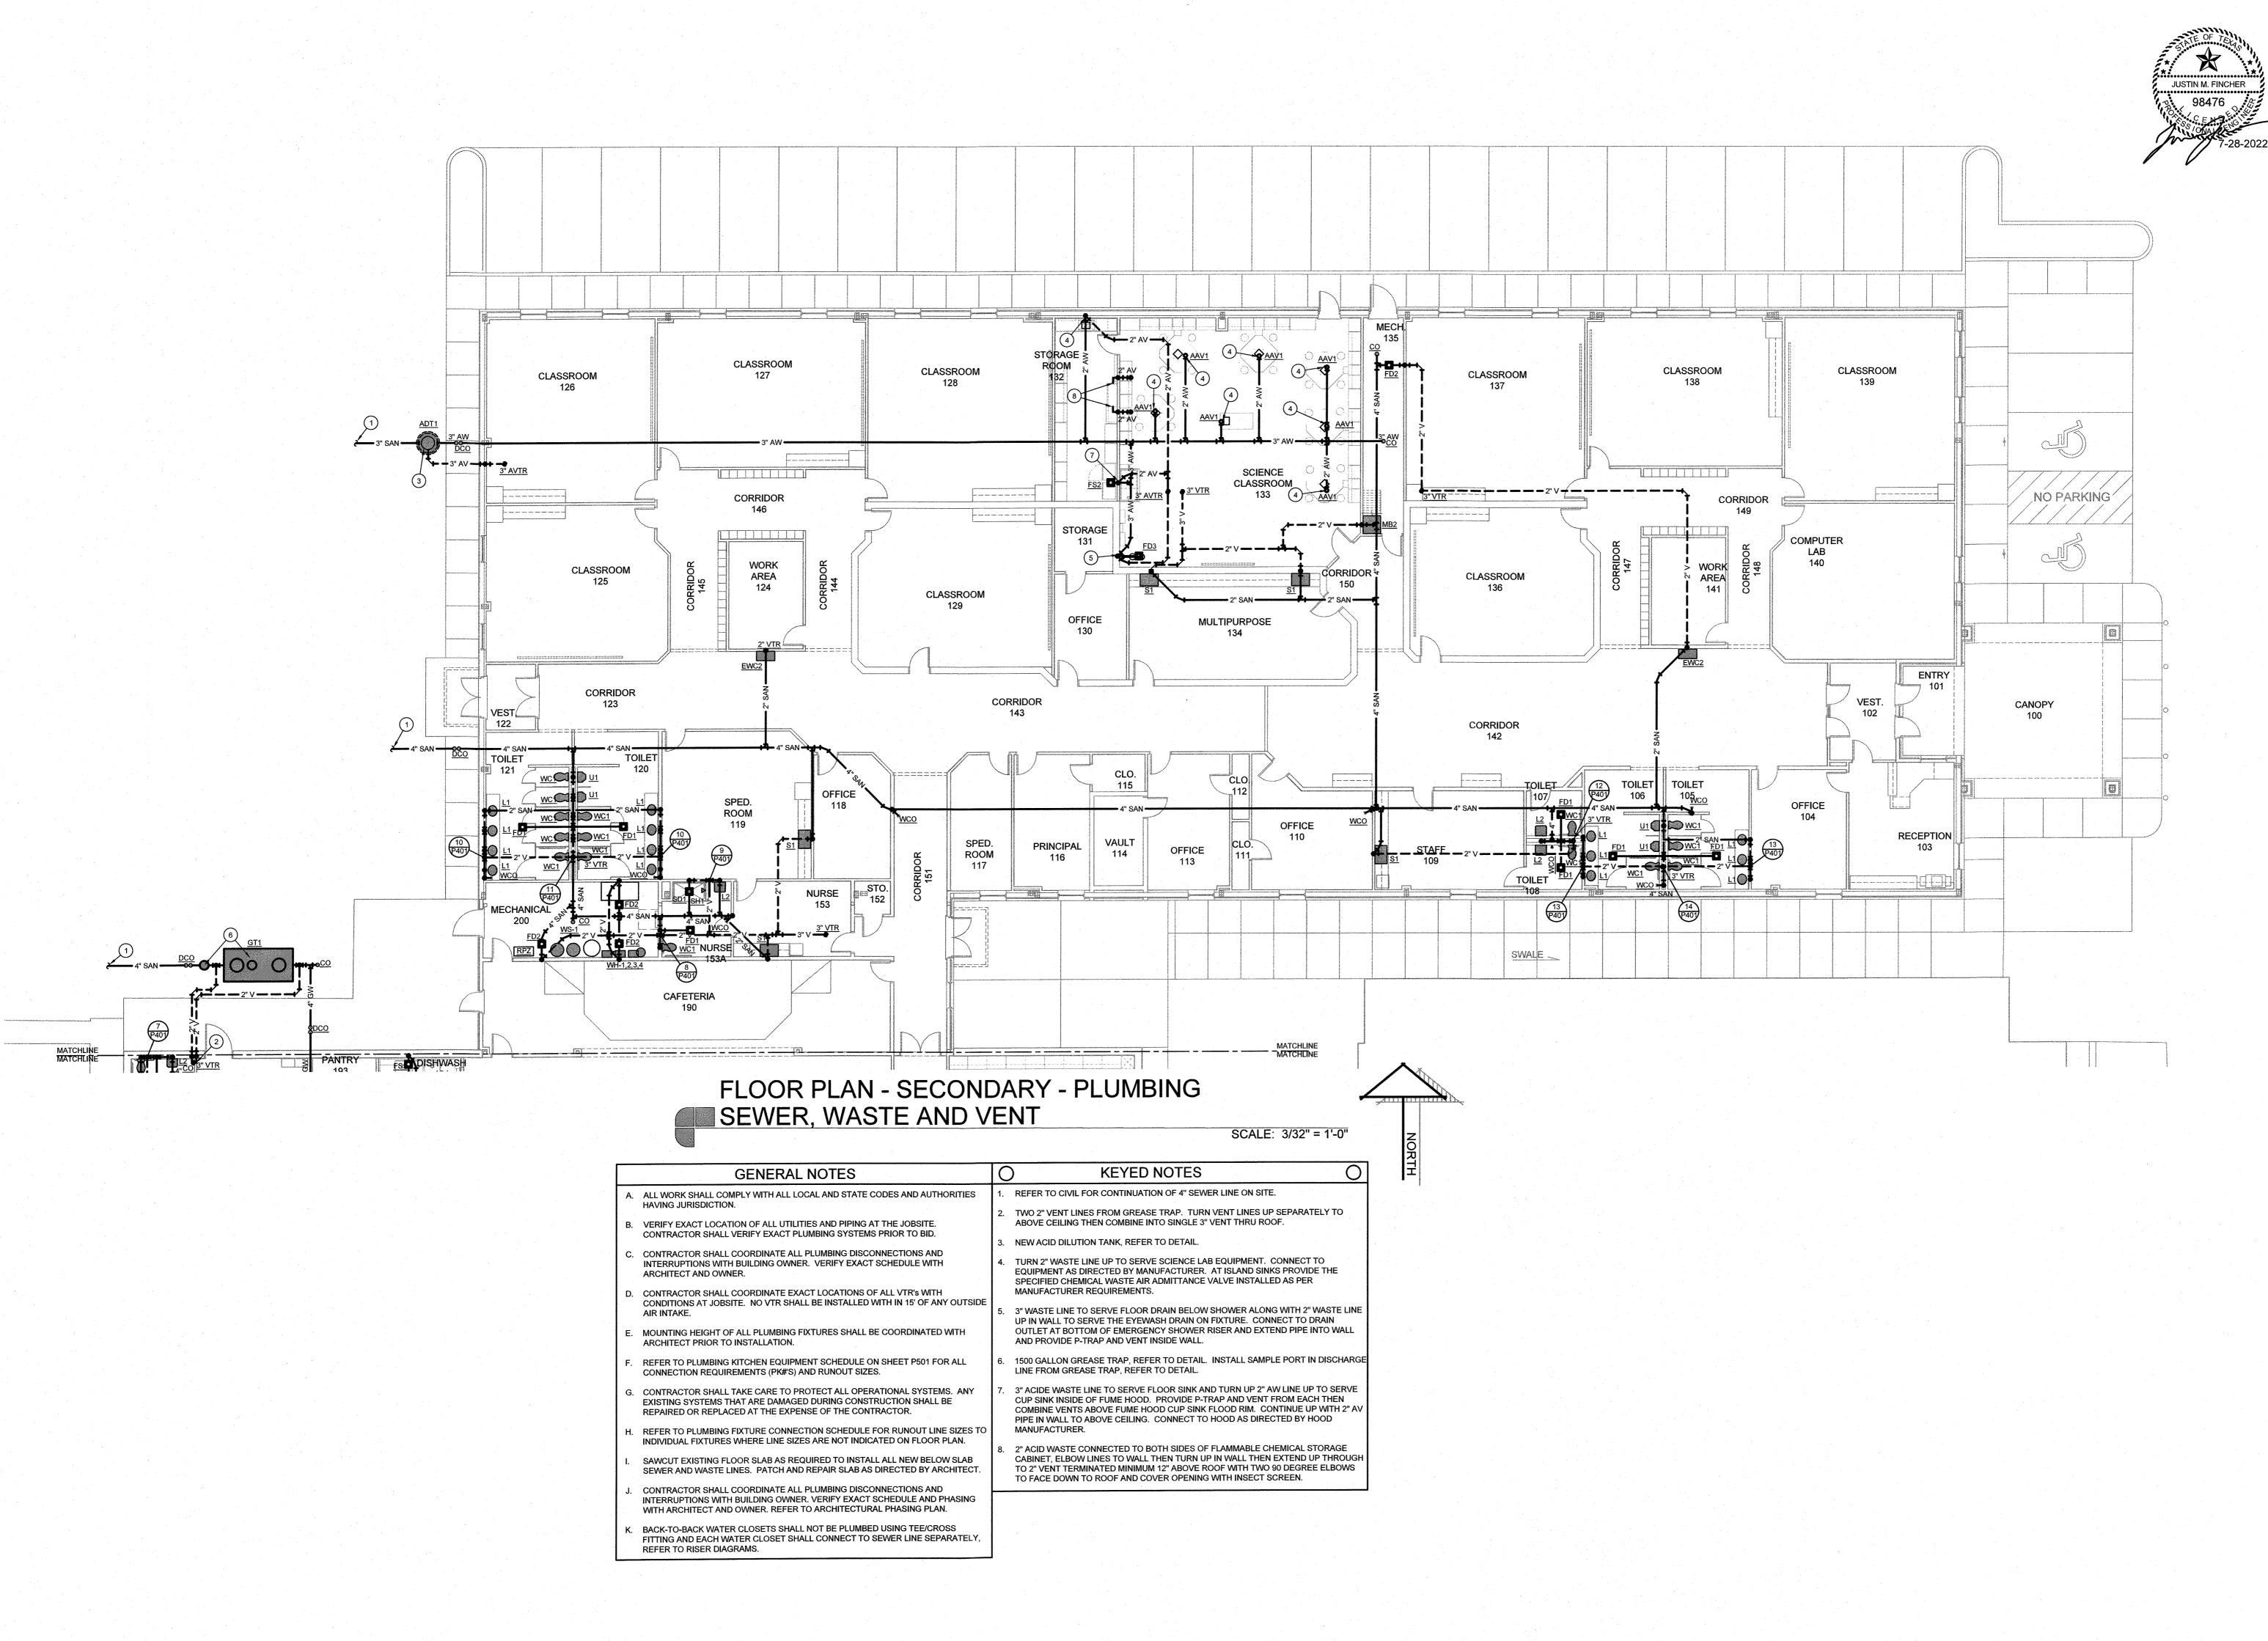
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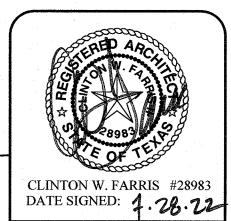
PROJECT NO. 20864.00

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DRAWN BY: FINCHER

DATE: 28 JULY 2022

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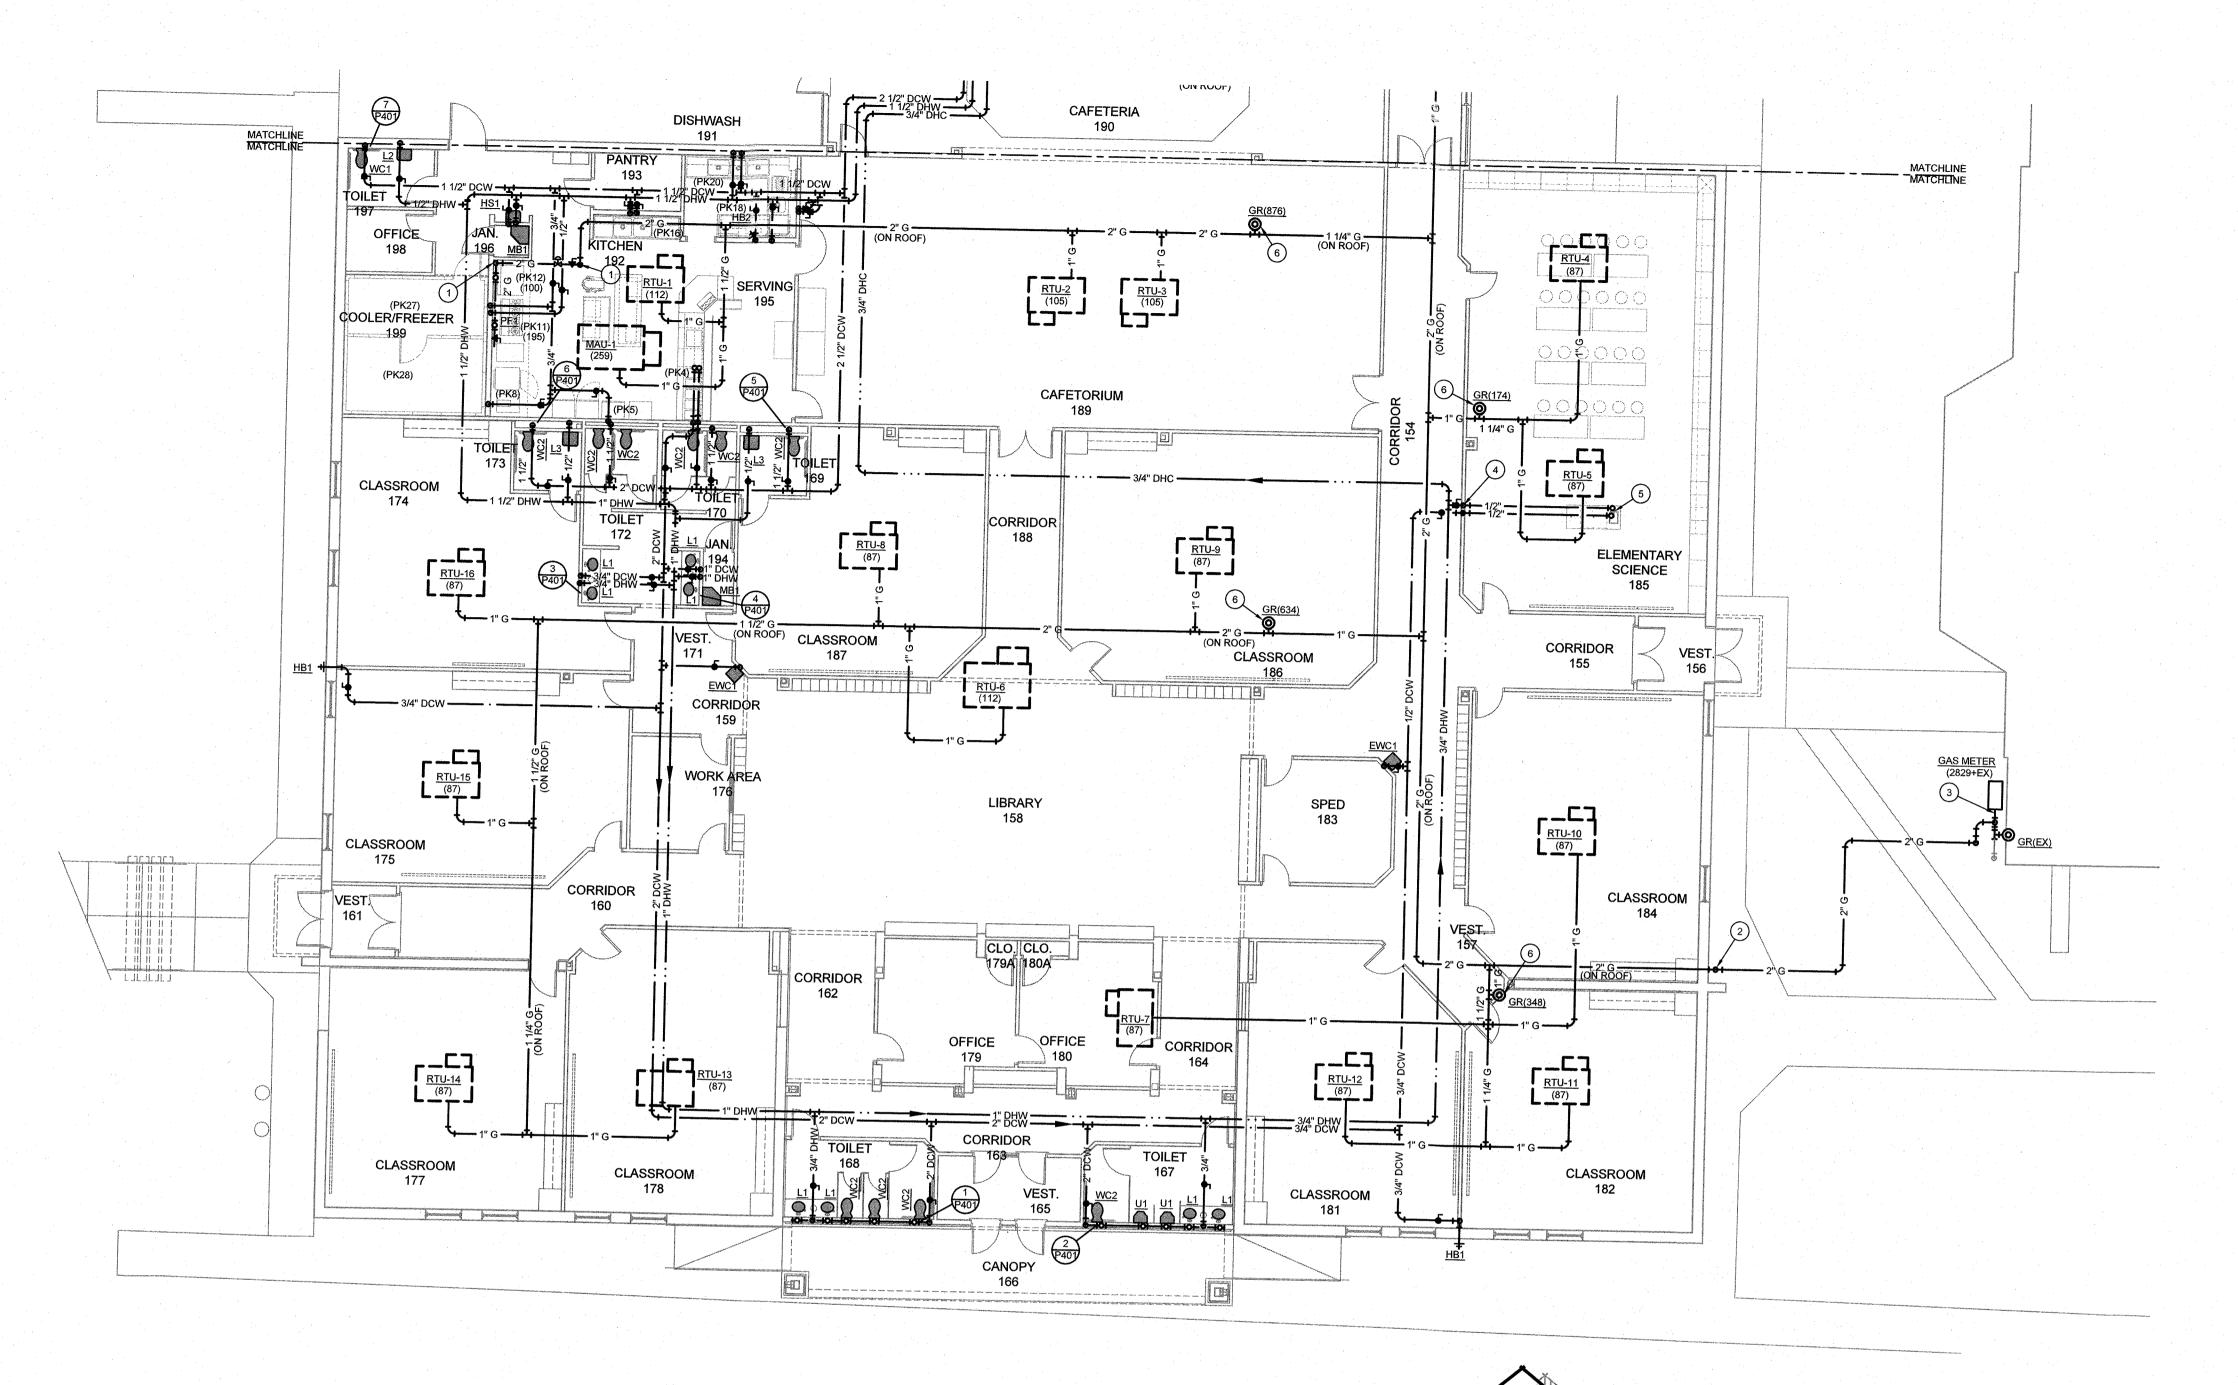
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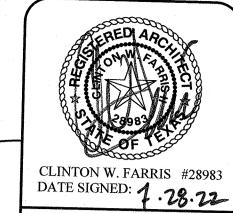





SCALE: 3/32" = 1'-0"

	GENERAL NOTES	TC) KEYED NOTES
Α.	ALL WORK SHALL COMPLY WITH ALL LOCAL AND STATE CODES AND AUTHORITIES HAVING JURISDICTION.	1.	TURN 2" GAS LINE DOWN THRU ROOF. ROUTE THROUGH MANUAL VALVE THEN THROUGH SOLENOID VALVE CONNECTED TO HOOD FIRE SUPPRESSION SYSTEM. CONTINUE LINE TO
В.	VERIFY EXACT LOCATION OF ALL EXISTING UTILITIES, PLUMBING FIXTURES, AND PIPING AT THE JOBSITE.		PROVIDE 6" DIRT LEG AT BOTTOM OF RISER AND PROVIDE 2" GAS HEADER BEHIND EQUIPMENT. PROVIDE TAP (REFER TO PLUMBING KITCHEN FOLIDMENT SOLVEDUE TO PROVIDE TAP (REFER TO PLUMBING KITCHEN FOLIDMENT SOLVEDUE TO PROVIDE TAP (REFER TO PLUMBING KITCHEN FOLIDMENT SOLVEDUE TO PROVIDE TAP (REFER TO PLUMBING KITCHEN FOLIDMENT SOLVEDUE TO PROVIDE TAP (REFER TO PLUMBING KITCHEN FOLIDMENT SOLVEDUE TO PROVIDE TAP (REFER TO PLUMBING KITCHEN FOLIDMENT SOLVEDUE TO PROVIDE TAP (REFER TO PLUMBING KITCHEN FOLIDMENT SOLVEDUE TO PROVIDE TAP (REFER TO PLUMBING KITCHEN FOLIDMENT SOLVEDUE TO PROVIDE TAP (REFER TO PLUMBING KITCHEN FOLIDMENT SOLVEDUE TO PROVIDE TAP (REFER TO PLUMBING KITCHEN FOLIDMENT SOLVEDUE TO PROVIDE TAP (REFER TO PLUMBING KITCHEN FOLIDMENT SOLVEDUE TO PROVIDE TAP (REFER TO PLUMBING KITCHEN FOLIDMENT SOLVEDUE TO PROVIDE TAP (REFER TO PLUMBING KITCHEN FOLIDMENT SOLVEDUE TO PROVIDE TAP (REFER TO PLUMBING KITCHEN FOLIDMENT SOLVEDUE TO PROVIDE TAP (REFER TO PLUMBING KITCHEN FOLIDMENT SOLVEDUE TO PROVIDE TAP (REFER TO PLUMBING KITCHEN FOLIDMENT SOLVEDUE TAP (REFER TO PLUMBING TAP (RE
C.	CONTRACTOR SHALL TAKE CARE TO PROTECT ALL OPERATIONAL SYSTEMS. ANY EXISTING SYSTEMS THAT ARE DAMAGED DURING CONSTRUCTION SHALL BE REPAIRED OR REPLACED AT THE EXPENSE OF THE CONTRACTOR		SIZE) WITH GAS VALVE AND FLEXIBLE GAS CONNECTION TO EACH PIECE OF EQUIPMENT. AT END OF 2" HEADER PROVIDE VALVE AND CAP LINE FOR FUTURE EXTENSION TO SERVE FUTURE KITCHEN EQUIPMENT BELOW HOOD.
D.	PRIME AND PAINT ALL EXTERIOR GAS LINES AS REQUIRED BY ARCHITECT. ALL ROOF MOUNTED GAS LINES SHALL BE PRIMED TO PROTECT FROM RUSTING.	2.	TURN 2" GAS LINE UP EXTERIOR WALL TO ABOVE GRADE TO VALVE AND DIRT LEG, REFER TO DETAIL. EXTEND UP TO ROOF. PROVIDE A SHEET METAL ENCLOSURE AROUND PIPING UP TO ROOF AND PAINT TO MATCH BUILDING AS DIRECTED BY ARCHITECT.
E.	MOUNTING HEIGHT OF ALL PLUMBING FIXTURES SHALL BE COORDINATED WITH ARCHITECT PRIOR TO INSTALLATION.	3.	EXISTING GAS METER TO BE REPLACED/MODIFIED ACCORDING TO REQUIREMENTS OF LOCAL GAS COMPANY TO ACCOMMODATE NEW TOTAL GAS LOAD AND DELIVERY PRESSURE OF 2 PSI FROM METER. COORDINATE FOR A TOTAL GAS LOAD OF 2829 MBTUH
F.	ARE INSTALLED ABOVE INACCESSIBLE CEILINGS.		TO VERIFY ON SITE). PROVIDE NEW 2" DISCHARGE LINE FROM METER TO CONNECT TO THIS NEW 2" 2 PSIGAS LINE PLUS NEW REGULATOR FOR EXISTING LINES AND
F.	REFER TO PLUMBING KITCHEN EQUIPMENT SCHEDULE ON SHEET P501 FOR ALL CONNECTION REQUIREMENTS (PK#'S) AND RUNOUT SIZES.	4	RECONNECTING BACK TO ANY REMAINING ACTIVE GAS LINES LEAVING THIS AREA.
G.	REFER TO PLUMBING FIXTURE SCHEDULE FOR RUNOUT LINE SIZES TO	•	TURN 1/2" DCW, AND 1/2" DHW LINES DOWN IN WALL TO ROUTE BELOW SLAB TO ISLAND SCIENCE LAB EQUIPMENT. THE BELOW SLAB WATER PIPING SHALL BE PEX PIPING.
	INDIVIDUAL FIXTURES WHERE LINE SIZES ARE NOT INDICATED ON FLOOR PLAN.	5.	CONNECT TO EQUIPMENT AS DIRECTED BY MANUFACTURER PROVIDE VALVE IN FACU.
Н.	LAVATORIES MUST BE PROVIDED WITH SPECIFIED FAUCET WITH ANTI-SCALD DEVICE OR ALTERNATE FAUCETS SHALL BE PROVIDED WITH		LINE BELOW COUNTER IN ACCESSIBLE LOCATION.
	SET TO PROVIDE MAXIMUM OF 100°F WATER TO HOT WATER SIDE OF ALL FAUCETS. VERIFY MOUNTING LOCATION OF MIXING VALVE WITH OWNER AND WITH ADA CLEARANCE. MIXING VALVE SHALL BE FOLIAL TO BRADLEY	6.	GAS REGULATOR MOUNTED IN GAS LINE ON ROOF TO REDUCE PRESSURE FROM 2 PSI TO OUNCE PRESSURE TO EQUIPMENT/APPLIANCES. REFER TO DETAIL ON SHEET P504 FOR ALL PIPING REQUIREMENTS OF REGULATOR.
-	S59.		









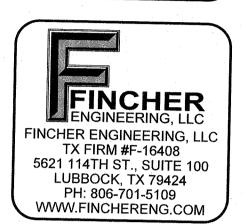


ADDITIONS AND RENOVATIONS

DRAWN BY: FINCHER DATE: 28 JULY 2022 REVISIONS 20864.00 SHEET NO.

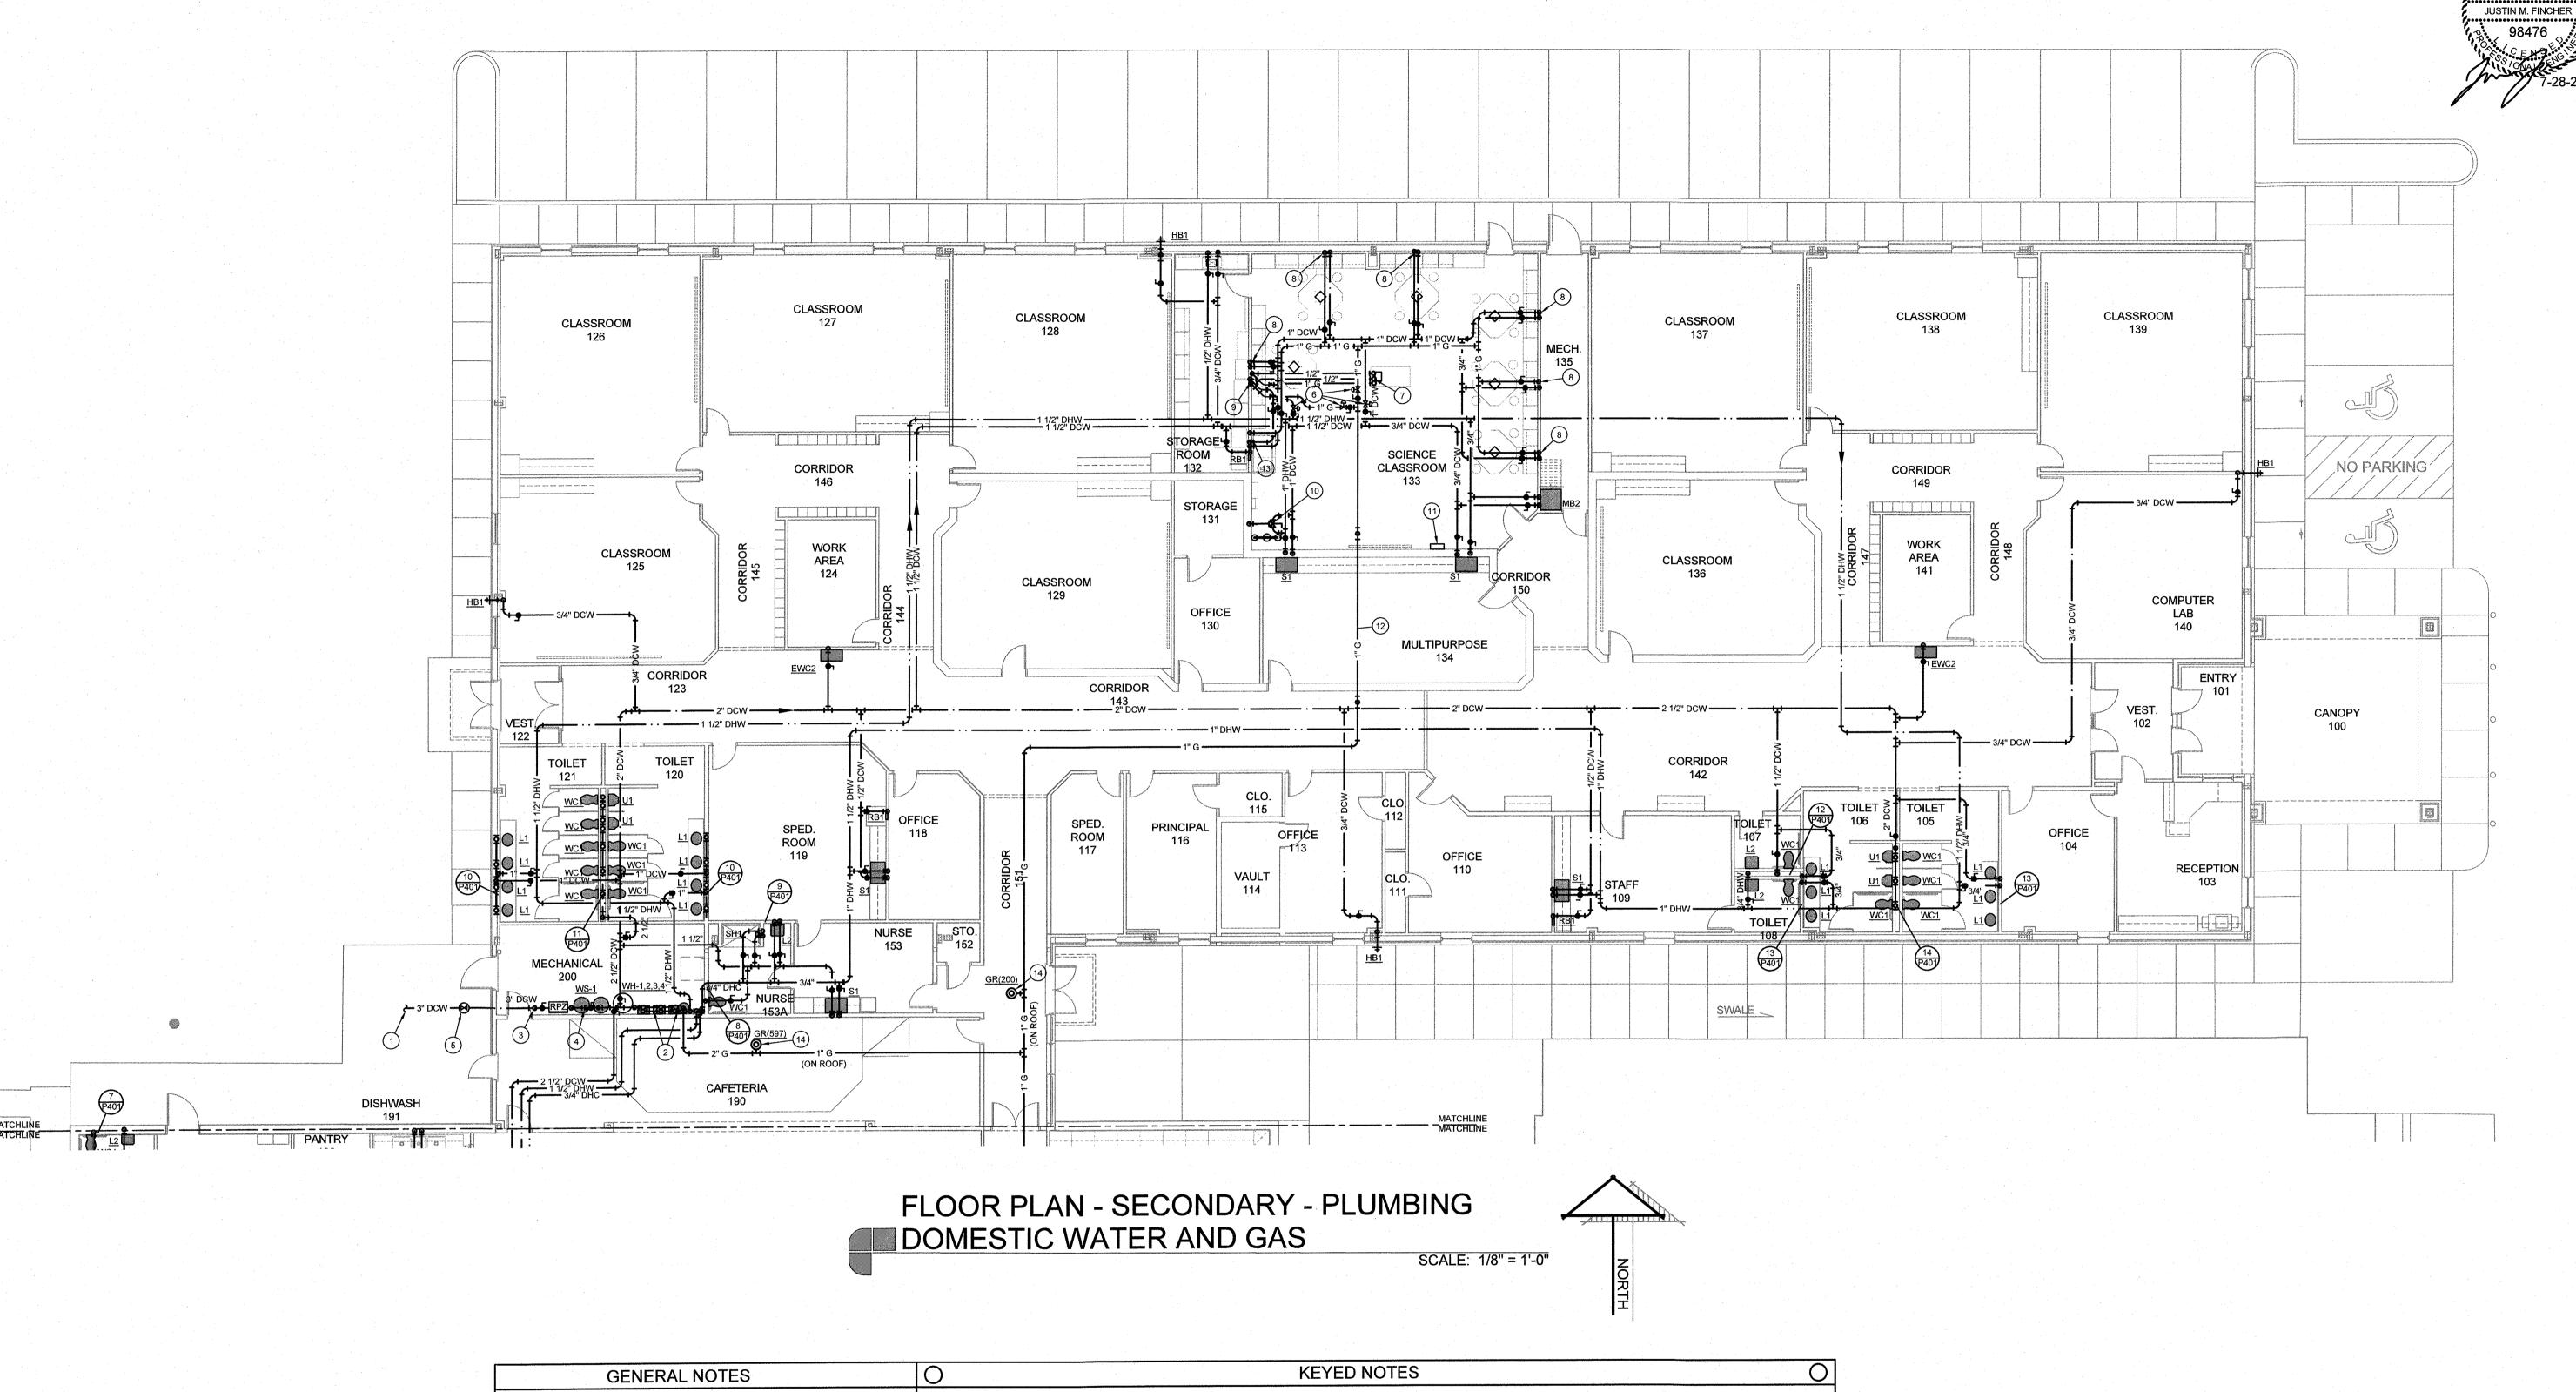

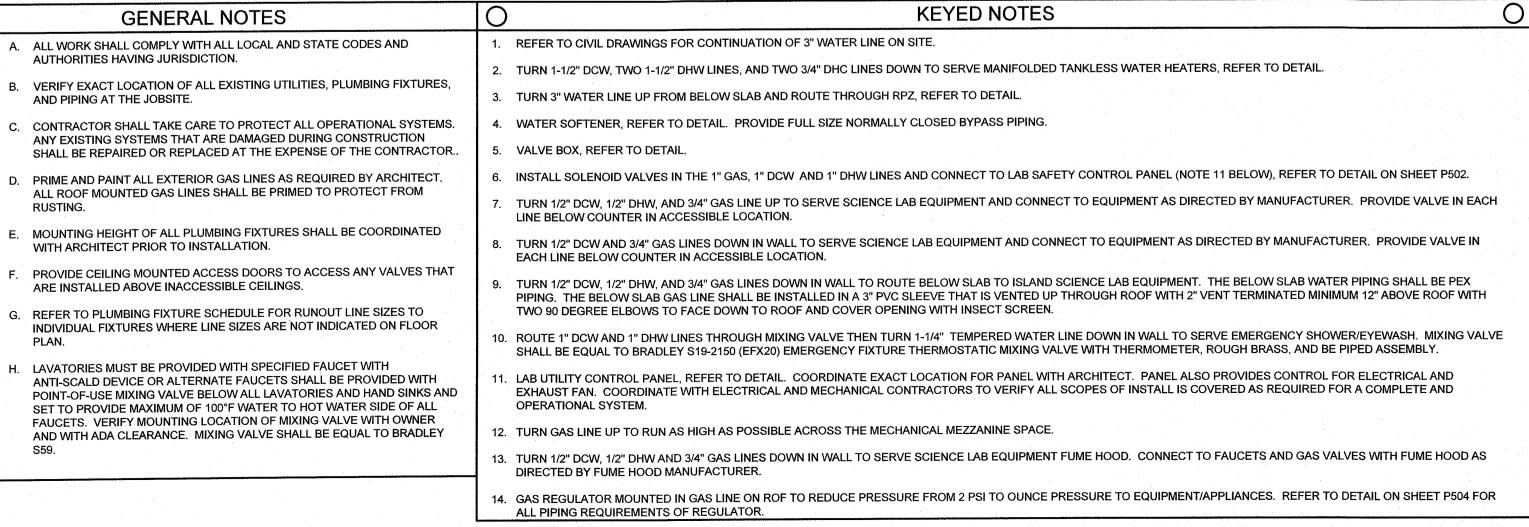

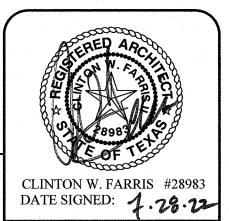





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VI.S.D. CAMP GORDON I.S.D.

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DRAWN BY: FINCHER

DATE: 28 JULY 2022

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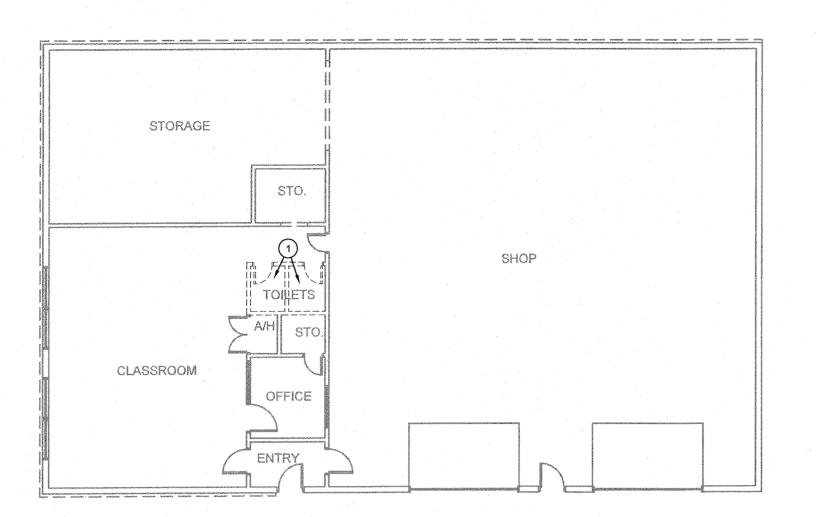
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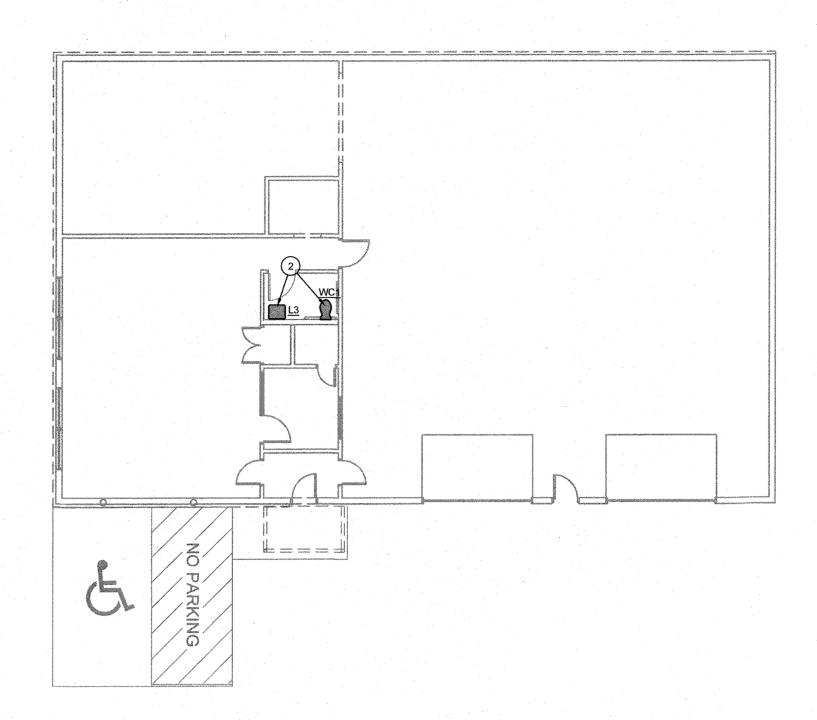
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P20'










FLOOR PLAN - AG BUILDING - PLUMBING

SCALE: 3/32" = 1'-0"

GENERAL NOTES	O KEYED NOTES O
A. ALL WORK SHALL COMPLY WITH ALL LOCAL AND STATE CODES AND AUTHORITIES HAVING JURISDICTION.	REMOVE EXISTING PLUMBING FIXTURES IN RESTROOM AND BACK TO PLUMBING LINES IN CHASE AND TO BELOW SLAB. PREPARE PIPING AS REQUIRED TO BE CONNECTED TO NEW FIXTURES AS SHOWN ON NEW WORK PLAN.
B. VERIFY EXACT LOCATION OF ALL EXISTING UTILITIES, PLUMBING FIXTURES, AND PIPING AT THE JOBSITE.	2. NEW WATER CLOSET AND LAVATORY IN NEW TAS COMPLIANT RESTROOM. CONNECT NEW WATER CLOSET AND LAVATORY TO EXISTING PLUMBING LINES SERVING THE
C. CONTRACTOR SHALL TAKE CARE TO PROTECT ALL OPERATIONAL SYSTEMS. ANY EXISTING SYSTEMS THAT ARE DAMAGED DURING CONSTRUCTION SHALL BE REPAIRED OR REPLACED AT THE EXPENSE OF THE CONTRACTOR	REMOVED RESTROOMS AS REQUIRED.
D. MOUNTING HEIGHT OF ALL PLUMBING FIXTURES SHALL BE COORDINATED WITH ARCHITECT PRIOR TO INSTALLATION.	
E. LAVATORIES MUST BE PROVIDED WITH SPECIFIED FAUCET WITH ANTI-SCALD DEVICE OR ALTERNATE FAUCETS SHALL BE PROVIDED WITH POINT-OF-USE MIXING VALVE BELOW ALL LAVATORIES AND HAND SINKS AND SET TO PROVIDE MAXIMUM OF 100°F WATER TO HOT WATER SIDE OF ALL FAUCETS. VERIFY MOUNTING LOCATION OF MIXING VALVE WITH OWNER AND WITH ADA CLEARANCE. MIXING VALVE SHALL BE EQUAL TO BRADLEY S59.	
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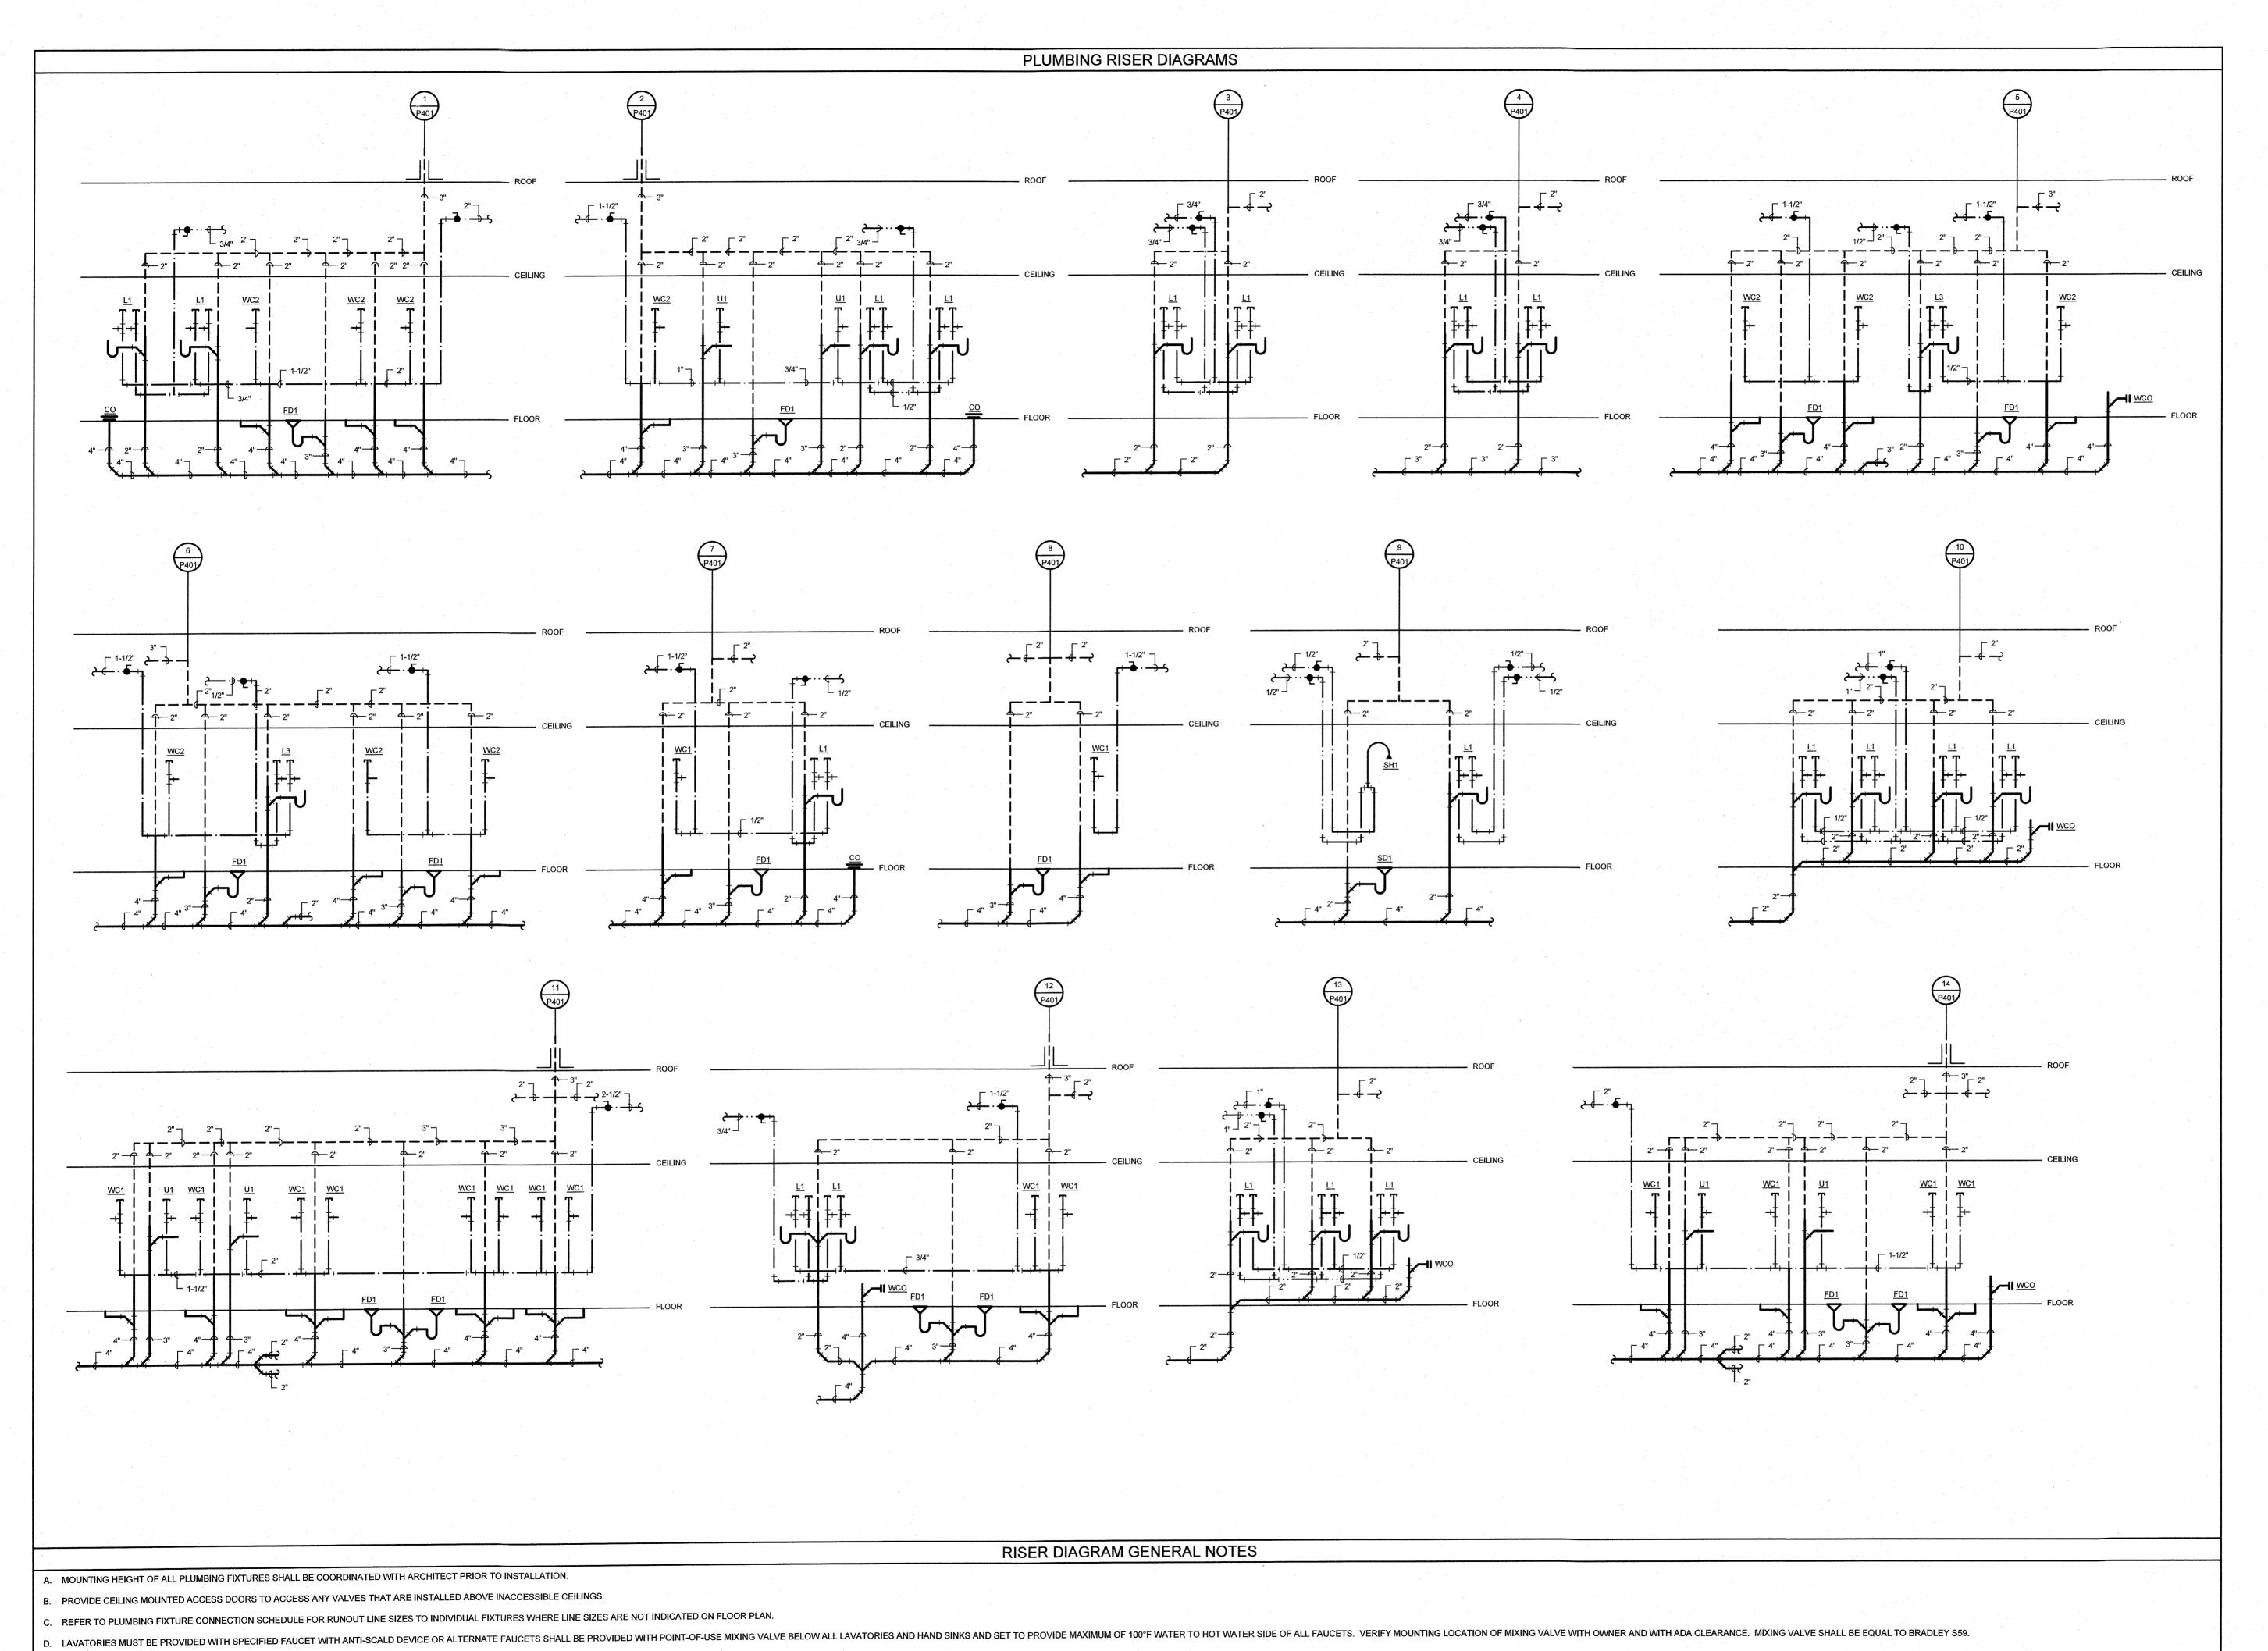


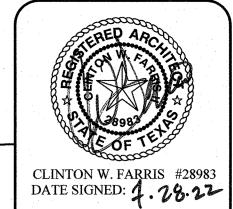


FINCHER ENGINEERING, LLC
TX FIRM #F-16408
5621 114TH ST., SUITE 100
LUBBOCK, TX 79424
PH: 806-701-5109
WWW.FINCHERENG.COM

DRAWN BY: FINCHER DATE: 28 JULY 2022

PROJECT NO. 20864.00





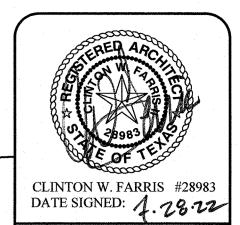





TX FIRM #F-16408 5621 114TH ST., SUITE 100 LUBBOCK, TX 79424 PH: 806-701-5109 WWW.FINCHERENG.COM

AMPUS S.D.

DON I.S.D. CAM FOR GORDON I.S.D.

112 RUSK STREET

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	PLUMBING FIXTURE SCHEDULE	ı	URE CO		
MARK	FIXTURE SPECIFICATION	DCW	DHW	SAN	T
	WATER CLOSETS			· .	· · · · · · · · · · · · · · · · · · ·
WC1	Fixture: American Standard 3043.001, 1.28 gpf, floor mounted elongated toilet, vitreous china, top spud, siphon jet, and 16.5" rim height. TAS compliant for adults. Flush Valve: Sloan Royal 111ESS, 1.28 GPF, angle stop bumper, polished chrome finish, top spud, true mechanical override, hardwired, sensor-operated. Provide Sloan Model EL-154 120V/24V transformer. TAS compliant	1-1/2"		4"	2"
WC2	Seat: Bemis 1955C white solid plastic open front Fixture: American Standard 2599.001, 1.28 gpf, floor mounted elongated toilet, 14" rim height. 15" toilet seat height for TAS compliant for ages 5 through 12. Flush Valve: Sloan Royal 111ESS, 1.28 GPF, angle stop bumper, polished chrome finish, top spud, true mechanical override, hardwired, sensor-operated. Provide Sloan Model EL-154 120V/24V transformer. TAS compliant	1-1/2"	-	4"	2"
· .	Seat: Bemis 1955C white solid plastic open front URINALS				1
U1	Fixture: American Standard 6400.014 vitreous china, sloping front stall urinal, and ¾" top spud. TAS compliant. Flush Valve: Sloan 186 SFSM, hard wired, mechanical override, 0.5 GPF, quiet exposed permex rubber diaphragm type flush valve. TAS compliant. Provide Sloan Model EL-154 120V/24V transformer.	3/4"		3"	2"
	LAVATORIES			· ·	
	Fixture: Kohler K-2196-1 vitreous china 20" x 17" self rim, with single facuet hole. TAS compliant.				
	Supply: Chicago Faucets E80-A11E-41ABCP, dual beam infrared sensor, integral spout, chrome plated, single hold deck mount, 1.0 GPM vandal proof pressure compensating laminar flow. Single supply for tempered water fed from below counter mixing valve. Power supply from 120 VAC to 12DC hard wired adapter. TAS compliant.				
	Mixing Valve: Bradley S59 point of use mixing valve to feed single temperature supply of faucet. Tailpiece: McGuire 155WC Cast Brass Chrome Plated Offset Wheelchair Strainer with polished chrome cast brass elbow and 17 gauge 1-1/4" inch seamless brass				
L1	offset tailpiece. P-trap: McGuire 8872C-F P-trap shall be chrome plated cast brass body with cleanout, with 17 gauge seamless wall bend, slip nuts and Chrome Plated Forged Brass	1/2"	1/2"	2"	2"
	Set Screw Flange. Stops, risers: McGuire BV2165-F Supply kit shall include commercial pattern chrome plated Quarter-Turn Brass Ball Valve with convertible loose key handle, Chrome Plated copper riser and Chrome Plated Forged Brass Set Screw Flange.		-	-	
	Protective Insulation: Plumberex X4333/X4114, Insulate per ADA 4.19.4 and or IBC all exposed lavatories drain piping, hot/cold stops and supplies. Protectors will consist of molded closed cell PVC, with anti-fungal and anti-microbial properties. To be one piece continuous smooth design.				
	Fixture: American Standard 9024.004EC, Decorum wall hung lavatory, 20x14, vitreous china, rear overflow, and 4" centers. TAS compliant.				
	Supply: Chicago Faucets E80-A11E-47ABCP, dual beam infrared sensor, integral spout, chrome plated, single hold deck mount, 1.0 GPM vandal proof pressure compensating laminar flow. Dual Supply for hot wand cold water service with user adjustable thermostatic (ASSE 1070) mixer. Power supply from 120 VAC to 12DC hard wired adapter. TAS compliant. This fixture does not require an under counter mixing valve as noted on the drawings since it has control built in. Any substitution from equal faucet without scald control must have point of use mixing valve installed below counter.				American Address of the Control of t
	Tailpiece: McGuire 155WC Cast Brass Chrome Plated Offset Wheelchair Strainer with polished chrome cast brass elbow and 17 gauge 1-1/4" inch seamless brass offset tailpiece.	4/00	4 /01	0"	011
L2	P-trap: McGuire 8872C-F P-trap shall be chrome plated cast brass body with cleanout, with 17 gauge seamless wall bend, slip nuts and Chrome Plated Forged Brass Set Screw Flange.	1/2"	1/2"	2"	2"
	Stops, risers: McGuire BV2165-F Supply kit shall include commercial pattern chrome plated Quarter-Turn Brass Ball Valve with convertible loose key handle, Chrome Plated copper riser and Chrome Plated Forged Brass Set Screw Flange.			-	
	Protective Insulation: Truebro Lav Shield rigid enclosure to enclose all components (traps, mixing valve, etc.). Enclosure to be 0.093" nominal wall thickness, stain resistant PVC, china white color, and secured to wall with stainless steel screws. ADA Compliant.	-			
	Carrier: Josam 17100 floor mounted Lavatory Carrier with concealed arms, leveling and securing screws, rectangular structural uprights and welded feet				
	Fixture: American Standard 9024.004EC, Decorum wall hung lavatory, 20x14, vitreous china, rear overflow, and 4" centers. TAS compliant. Supply: Chicago Faucets E80-A11E-41ABCP, dual beam infrared sensor, integral spout, chrome plated, single hold deck mount, 1.0 GPM vandal proof pressure compensating laminar flow. Single supply for tempered water fed from below counter mixing valve. Power supply from 120 VAC to 12DC hard wired adapter. TAS compliant.				
	Mixing Valve: Bradley S59 point of use mixing valve to feed single temperature supply of faucet. Tailpiece: McGuire 155WC Cast Brass Chrome Plated Offset Wheelchair Strainer with polished chrome cast brass elbow and 17 gauge 1-1/4" inch seamless brass			-	
L3	offset tailpiece. P-trap: McGuire 8872C-F P-trap shall be chrome plated cast brass body with cleanout, with 17 gauge seamless wall bend, slip nuts and Chrome Plated Forged Brass	1/2"	1/2"	2"	2"
	Set Screw Flange. Stops, risers: McGuire BV2165-F Supply kit shall include commercial pattern chrome plated Quarter-Turn Brass Ball Valve with convertible loose key handle, Chrome Plated copper riser and Chrome Plated Forged Brass Set Screw Flange.			-	
	Protective Insulation: Truebro Lav Shield rigid enclosure to enclose all components (traps, mixing valve, etc.). Enclosure to be 0.093" nominal wall thickness, stain resistant PVC, china white color, and secured to wall with stainless steel screws. ADA Compliant.				
	Carrier: Josam 17100 floor mounted Lavatory Carrier with concealed arms, leveling and securing screws, rectangular structural uprights and welded feet				
	ELECTRIC WATER COOLERS Fixture: Halsey Taylor HTHB-HVRGRN8-WF, vandal resistant, touchless sensor activated bottle filling station and single drinking fountain, 8.0 GPH of 50 degree F				<u> </u>
EWC1	drinking water, visual filter monitor, green counter, vandal resistant, stainless steel finish, and mechanically activated bubbler. Verify mounting height with Architect. TAS compliant. Provide with 2 extra water filters P-trap: McGuire 8872C P-trap shall be chrome plated cast brass body with cleanout, with 17 gauge seamless wall bend, slip nuts and Chrome Plated Set Screw	1/2"		2"	2"
	Flange. Stop: McGuire BV175 Supply shall include commercial pattern chrome plated Quarter-Turn Brass Ball Valve with convertible loose key handle.		-	-	
	Carrier: Josam 17560-WCBL floor mounted Water Cooler Carrier with rectangular structural uprights and welded feetcontinuous smooth design. Fixture: Halsey Taylor HTHB-HVRGRN8BL-WF, vandal resistant, touchless sensor activated bottle filling station and bi-level drinking fountain, 8.0 GPH of 50 degree F				
	drinking water, visual filter monitor, green counter, vandal resistant, stainless steel finish, and mechanically activated bubbler. Verify mounting height with Architect. TAS compliant. Provide with 2 extra water filters				
EWC2	Apron: Halsey Taylor HTVZAPR, Cane touch apron, polymer construction. Apron shall extend to exactly 27" A.F.F. as per TAS requirements. P-trap: McGuire 8872C P-trap shall be chrome plated cast brass body with cleanout, with 17 gauge seamless wall bend, slip nuts and Chrome Plated Set Screw Flange.	1/2"		2"	2"
	Stop: McGuire BV175 Supply shall include commercial pattern chrome plated Quarter-Turn Brass Ball Valve with convertible loose key handle. Carrier: Josam 17560-WCBL floor mounted Water Cooler Carrier with rectangular structural uprights and welded feetcontinuous smooth design.				
	SINKS				
	Fixture: Elkay LRAD-3321, 33"x 21-1/4", 6" deep, double compartment with off-center drain outlets, 18 gage type 304 self rimming stainless steel with 3 holes. TAS				
	Supply: Chicago Faucets No. 2200-8ABCP, Sink Faucet for hot and cold water, single lever, deck-mounted with 8" fixed centers, chrome plated. Integral cast brassspout, 4-3/4" center-to-center. 2.2 GPM (8.3 L/min) pressure compensating Softflo aerator. 2-3/4" metal lever handle. Ceramic quarter-turn cartridge, features				PROPERTY AND A CONTRACT OF THE ANALYSIS OF THE
S 1	square, tapered stem. Flexible stainless steel supply hoses with 3/8" compression fitting. TAS compliant Strainer: McGuire 1151WC, adjustable brass offset sink strainer with 17 gauge seamless brass waste arm and tailpiece, cast brass slip nuts and heavy cast elbow. P-trap: McGuire 8912C-F P-trap shall be chrome plated cast brass body with cleanout, with 17 gauge seamless wall bend, slip nuts and Chrome Plated Forged Brass	1/2"	1/2"	2"	2"
	Set Screw Flange. Stops, risers: McGuire BV2165-F Supply kit shall include commercial pattern chrome plated Quarter-Turn Brass Ball Valve with convertible loose key handle, Chrome Plated copper riser and Chrome Plated Forged Brass Set Screw Flange.	-	-		
	Protective Insulation: Plumberex X4333/X4114, Insulate per ADA 4.19.4 and or IBC all exposed lavatories drain piping, hot/cold stops and supplies. Protectors will consist of molded closed cell PVC, with anti-fungal and anti-microbial properties. To be one piece continuous smooth design.	-			
	Fixture: Advance Tabco 7-PS-68, stainlesss steel hand sink, all tig welded, heavy gauge type 304 stainless steel, 4" o.c. splash mounted gooseneck facuet with wrist handles. Provide with wall mounting bracket.	-			
HS1	P-trap: McGuire 8912C-F P-trap shall be chrome plated cast brass body with cleanout, with 17 gauge seamless wall bend, slip nuts and Chrome Plated Forged Brass Set Screw Flange. Stops, risers: McGuire BV2165-F Supply kit shall include commercial pattern chrome plated Quarter-Tum Brass Ball Valve with convertible loose key handle, Chrome	1/2"	1/2"	2"	2"
	Plated copper riser and Chrome Plated Forged Brass Set Screw Flange.				1

MARK	FIXTURE SPECIFICATION	1	URE CO	* .	
WARK	FIXTURE SPECIFICATION	DCW	DHW	SAN	VEN
	SHOWERS			:	
SH1	Fixture: Chicago SH-TP6-00-022 thermostatic/pressure balancing shower fitting with automatic drain and hand spray, 2.5 gpm hand spray with pause control, two 34" stainless steel hoses with automatic hose drain, 48" wall mounted slide bar with hand spray holder, integral service stops with checks, and thermostatic/pressure balancing cartridge. TAS Compliant.	1/2"	1/2"		
	MOP BASINS				
	Fixture: Stern-Williams SB-1502-BP, 24x24x12 corner precast terrazzo, 3" integral drain body, stainless steel back panels and stainless steell cap				
MB1	Supply: T&S Brass B-0665-BSTR, Service Sink Faucet with rough chrome finish, built in stops, vacuum breaker, lever handles, wall brace and 3/4" garden hose outlet	3/4"	3/4"	3"	2"
	Accessories: T&S Brass B-0653 & B-0654, Reinforced PVC hose and mop hanger				
	Fixture: Stern-Williams SB-902-BP, 24x24x12 precast terrazzo, 3" integral drain body, stainless steel back panels, and stainless steel cap.				
MB2	Supply: T&S Brass B-0665-BSTR, Service Sink Faucet with rough chrome finish, built in stops, vacuum breaker, lever handles, wall brace and 3/4" garden hose outlet	3/4"	3/4"	3"	2"
 	Accessories: T&S Brass B-0653 & B-0654, Reinforced PVC hose and mop hanger				
	SPECIALTIES				
RPZ	Fixture: Watts LF009-QT-S lead free reduced pressure zone assembly. Provide with strainer. Provide with quarter turn valves for 1/4"-2" line sizes and NRS gate valves for lines 2-1/2" - 3". Provide in all locations shown on plan and as required by authority having jurisdiction.		LINE	SZE	
	Air Gap: Provide with air gap and extend to spill to nearest floor drain. Fixture: Woodford Model 68, automatic draining with ASSE 1052 approved model 50HA high flow double check backflow preventer,				
HB1	3/4" inlet and outlet. Hardended stainless steel operating stem and one-piece valve plunger to control both flow and drain functions. Exterior finish to be stainless steel. Loose tee key to be furnished with each hydrant.	3/4"			
HB2	Fixture: Woodford Model MB24 wall faucet with vacuum breaker in locking modular box.	3/4"			-
RB1	Fixture: Guy Gray SSIB1 stainless steel ice maker box with quarter turn valves.	1/2"			
PF1	Fixture: Chicago Faucets 517-GCABCP Pot and Kettle Filler, wall-mounted with adjustable arms for 7-1/4" - 8-3/4" centers. Chrome plated. Double-jointed swingspout, 18" center-to-center. 2-3/8" metal, vandal-proof, lever handles with sixteen-point, tapered broach and secured blue and red index buttons. rebuildable compression cartridge, opens and closes 90°, closes with water pressure, features square, tapered stem. 3/8" offset inlet supply arm with integral check with 1/2" NPT female thread inlet. 2-5/16" diameter slip flange. Mount on wall above range, verify exact location and height with Architect prior to rough-in.		1/2"	-	-
FD1	Fixture: Floor Drains shall be coated cast iron, two piece body, non puncturing flashing collar with weep holes and 6" adjustable satin Nikaloy square strainer equal to Josam 30000-6S. Provide all floor drains with trap seal equal to ProSet Trap Guard and install according to manufacturer's instructions.			3"	2"
FD2	Fixture: Floor Drains shall be coated cast iron, two piece body, non puncturing flashing collar with weep holes, square top, heavy duty, loose set laminated Satin Finish Nikaloy Grate and removable sediment bucket equal to Josam 37820-19. Provide all floor drains with trap seal equal to ProSet Trap Guard and install according to manufacturer's instructions.			3"	2"
FD3	Fixture: CPVC acid waste floor drain with 5" round CPVC grate, 1/8" perforated sidement strainer equal to Spears LabWaste floor drain. Provide all floor drains with trap seal equal to ProSet Trap Guard and install according to manufacturer's instructions.			3" AW	2" A
FS1	Fixture: Floor Sink shall be square cast iron 12x12x6 with acid resisting interior, double drainage flange with weep holes, aluminum internal dome strainer, and cast iron, non traffic, acid-resisting Grate equal to Josam 49340-3 (1/2 grate).			3"	2"
FS2	Fixture: Floor Sink shall be square cast iron 8x8x6 with acid resisting interior, double drainage flange with weep holes, aluminum internal dome strainer, and Nikaloy sanitary sloped Rim and Grate equal to Josam 49300-NB-4 (3/4 grate).			3"	2"
SD1	Fixture: Floor Drains shall be coated cast iron, two piece body, non puncturing flashing collar with weep holes and 5" adjustable chrome plated round strainer equal to Josam 30000-5A-CP. Provide all floor drains with trap seal equal to ProSet Trap Guard and install according to manufacturer's instructions.	<u></u>		2"	2"
AAV1	Fixture: Automatic air valves for acid waste applications using valves equal to Studor Chem-Vent and Mini-Vent valves installed according to manufacturers installation requirements.		LINE	SZE	
	Floor cleanouts in finished floors shall be equal to Josam 55000-1 with medium-duty scoriated secured round satin Nikaloy Cover.		-		
	Floor cleanouts in floors with thin flooring shall be equal to Josam 55000-1-13 with recessed top for flooring. Floor cleanouts in tiled floors shall be equal to Josam 55000-1-SQ with scoriated secured square satin Nikaloy Cover.				
CLEANOUTS	Floor cleanouts in carpeted floors shall be equal to Josam 55000-14 with scoriated secured round cover and carpet cleanout marker.				
CO, WCO, DCO	Floor cleanouts in unfinished areas shall be equal to Josam 55000-1-SD with special duty scoriated secured round laminated satin Nikaloy Cover.	LIN	NE SIZE	UP TO	4"
	Exterior cleanouts subject to heavy wheel traffic shall be equal to Josam 58680-CO Cast Iron Access Frame with anchor flanges and heavy-duty scoriated secured cover.				
	Wall cleanouts shall be concealed behind Stainless Steel access cover with screw equal to Josam 58600.			-	

	KITCHEN EQU	IPMENT	PLUM	BING (CONN	IECTION SCHEDU	JLE (PK#)	
ITEM CODE	DESCRIPTION				Р	LUMBING CONNECTIONS		
HENICODE	DESCRIPTION	DCW	DHW	WASTE	VENT	INDIRECT WASTE TO FS	GAS	NOTES
PK4	HOOT FOOD UNIT - 5 WELL	1/2"	1/2"	AV 500 500		1" (x5)		
PK5	ICE MACHINE	1/2"				3/4" (x2)	·	1
PK8	HOT WATER DISPSNSER	1/2"					agent en	1
PK11	RANGE AND GRIDDLE					Pri Ala Ma	1-1/4" (195 MBH)	
PK12	CONVECTION OVEN						1" (100 MBH)	
PK16	TWO COMPARTMENT SINK	1/2"	1/2"			1-1/2" (x2)		2
PK18	SOILED DISH SINK	1/2"	1/2"			1-1/2"	wa 60 m	2
PK18A	DISPOSER	1/2", 3/4"				2"		3
PK19	DISHWASHER	3/4"	3/4"			2"	-	1,2
PK20	THREE COMPARTMENT SINK	1/2"	1/2"		:	1-1/2" (x3)	EA 500 -00	2
PK27	WALK IN FREEZER	***			Manage Andre	1"		
PK28	WALK IN COOLER					1"		
					-			

GENERAL NOTES:

- A. ALL ROUGH-IN HEIGHTS AND LOCATIONS SHALL BE AS DIRECTED BY FOODSERVICE EQUIPMENT PROVIDER.
- B. MOUNTING HEIGHTS ARE TO BE VERIFIED BY FOODSERVICE EQUIPMENT PROVIDER AND ADJUST AS REQUIRED.
- C. PROVIDE RPZ BACKFLOW PREVENTERS IN ALL WATER LINES AT CONNECTIONS TO EQUIPMENT AS REQUIRED BY AUTHORITY HAVING
- D. PLUMBING CONTRACTOR SHALL INSTALL ALL FAUCETS AND PLUMBING ACCESSORIES PROVIDED BY THE FOOD SERVICE EQUIPMENT
- PROVIDER.

 E. ALL GAS AND WATER CONNECTIONS TO KITCHEN EQUIPMENT SHALL BE OF AMPLE LENGTH TO ALLOW FOR EQUIPMENT TO MOVE FOR
- CLEANING.
 F. QUICK DISCONNECTS TO BE SUPPLIED WITH KITCHEN EQUIPMENT WITH ALL GAS AND WATER EQUIPMENT AND INSTALLED BY PLUMBING


CONTRACTOR. NOTES INDICATED IN SCHEDULE ABOVE:


- 1. ROUTE WATER LINE THROUGH RPZ BACKFLOW PREVENTER EQUAL TO WATTS #SS009. PROVIDE AIR GAP AND DRAIN LINE TO NEAREST FLOOR
- SINK. RPZ'S SHALL BE LOCATED IN ACCESSIBLE LOCATION NEVER PLACED BEHIND A PIECE OF EQUIPMENT.

2. ACCESSORIES PROVIDED LOOSE WITH FOODSERVICE EQUPMENT AND TO BE FIELD INSTALLED BY PLUMBING CONTRACTOR.

3. ROUTE WATER LINE THROUGH BALL VALVE, PRESSURE REDUCING VALVE, SOLENOID VALVE, AND VACUUM BREAKER ALL INSTALLED PER DISPOSER MANUFACTURER PIPING REQUIREMENTS. ALL PROVIDED AND INSTALLED BY PLUMBING CONTRACTOR.



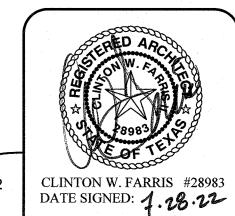

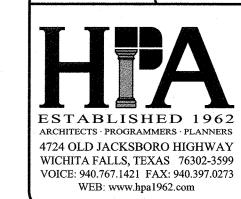




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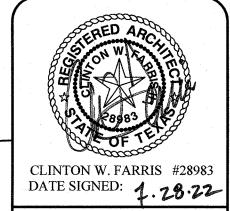
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- BALL VALVE








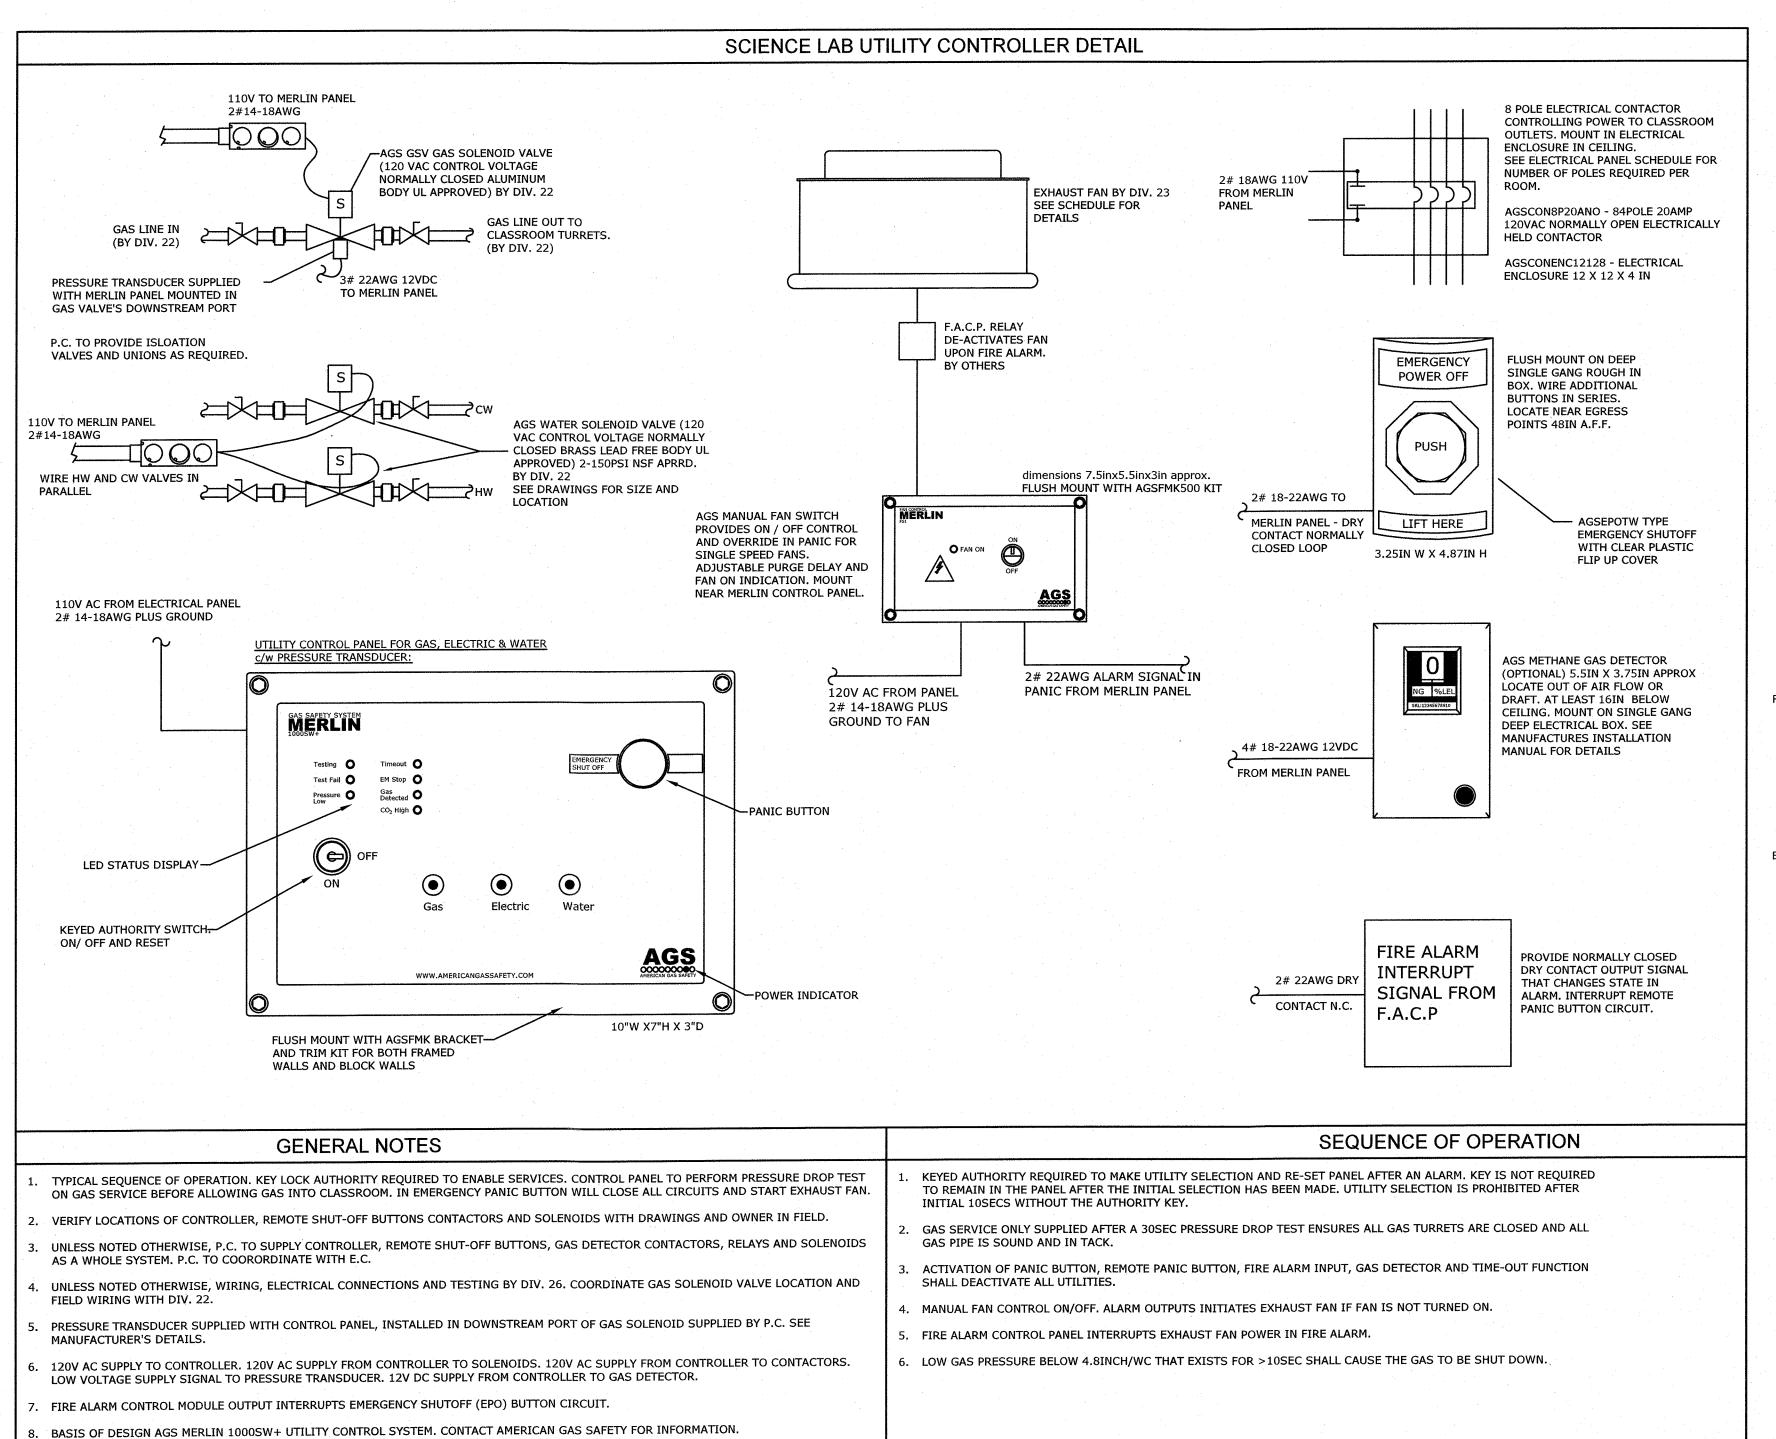


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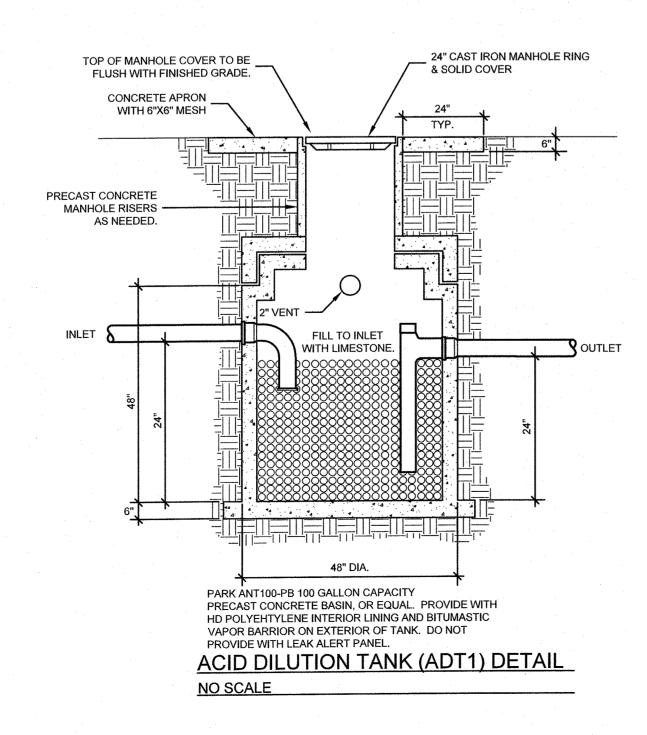
MARK	FUEL	INPUT	UEF	FLOW RATE	EXAMPLE
WH-1	GAS	199 MBH	0.93	5.5 GPM AT 70°F RISE	A.O.SMITH ATI-540P-N
WH-2	GAS	199 MBH	0.93	5.5 GPM AT 70°F RISE	A.O.SMITH ATI-540P-N
WH-3	GAS	199 MBH	0.93	5.5 GPM AT 70°F RISE	A.O. SMITH ATI-540P-N

MARK	TANK CAP.	FUEL	INPUT	RECOVERY GPH	ELECTRICAL DATA	EXAMPLE
WH-4	6 GAL.	ELEC.	1650 W	8 GAL.	120 V, 1Ø, 60 HZ	A.O. SMITH EJC-6

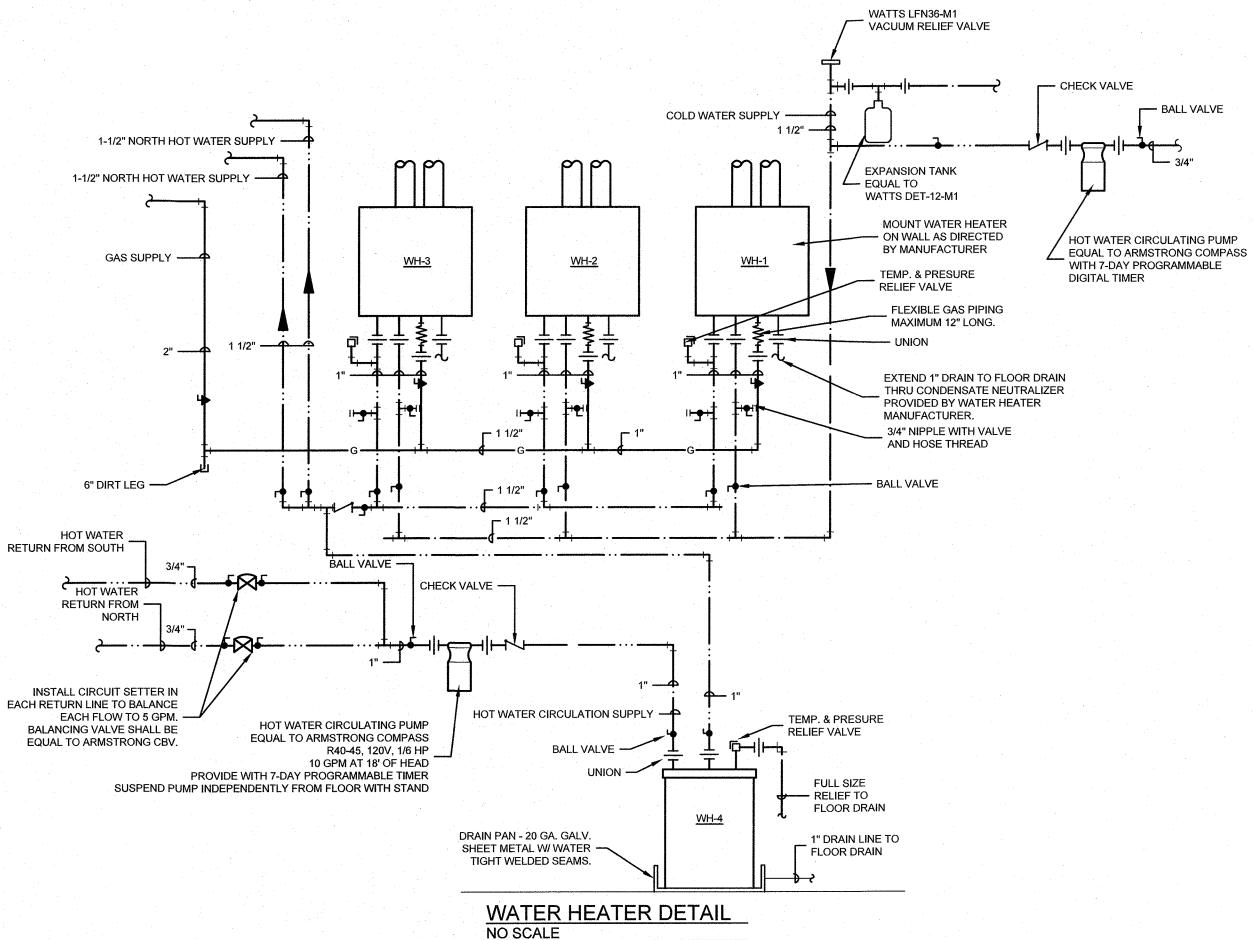

WATER	SOFT	TENER	PIPIN	G DET	Α
NO SCALE				,	

	-				W	ATER SO	OFT	ENER	SCH	IEDUI	LE							
	DIMENSIONS (INCHES)									· · · · · · · · · · · · · · · · · · ·								
MODEL	WIDTH	HEIGHT		TANK DIA.		INLET/OUTLET PIPE SIZES	DRAIN SIZE	FLOOR TO INLET		BRINE TANK HEIGHT	MAX. CAPACITY KGR @ SALT DOSAGE	RESIN VOLUME ft ³	CONTINUOUS FLOW gpm @ 15 psi drop	PEAK FLOW gpm @ 25 psi drop	DRAIN FLOW gpm	MIN. DRAIN PIPE SIZE IN.	DUPLEX OPER, WT. lbs.	
CULLIGAN HCE-210-2 DUPLEX	82	.80	22.5	21	67.1	2.0	1.0	69.3	24	50	210 @ 105	7	58	76	8	1.0	2950	1310
WATER SOFTENER NOTES: (1) ALL DIMENSIONS ARE ± 1 INCH (2) (2) UNIONS SHOULD BE LOCATED OF COMMENTS OF DISSIMILAR METALS FITTINGS MAY REDUCE GALVANI (4) ALLOW 6-12 INCHES BEHIND THE (5) SYSTEM USES FRP TANKS WHICK (6) TO PERMIT THE OBSERVATION OF COMMENTS OF COMMENT	N INLET A IN A PIPI C CORRO UNIT FOI I MUST N	ND OUT NG SYST SION. R PLUME OT BE S	LET CO TEM IS I BING AN UBJEC	NNECT NOT RE ID DRA FED TO	TONS OF ECOMME IN LINES VACUUI	CONTROL VAL NDED. WHERE AND 12" ABOV M. SIPHON BRE	DISSIN E OVER EAK ON	IILAR META RALL HEIGH DRAIN LIN	LS MUS IT FOR S E. INSTA	T BE CON ERVICE A ALL VACU	ACCESS AND F	ILLING THE	SALT CONTA	INER. SERVICE LI	NE IS SU	JBJECT TO A	VACUUM.	

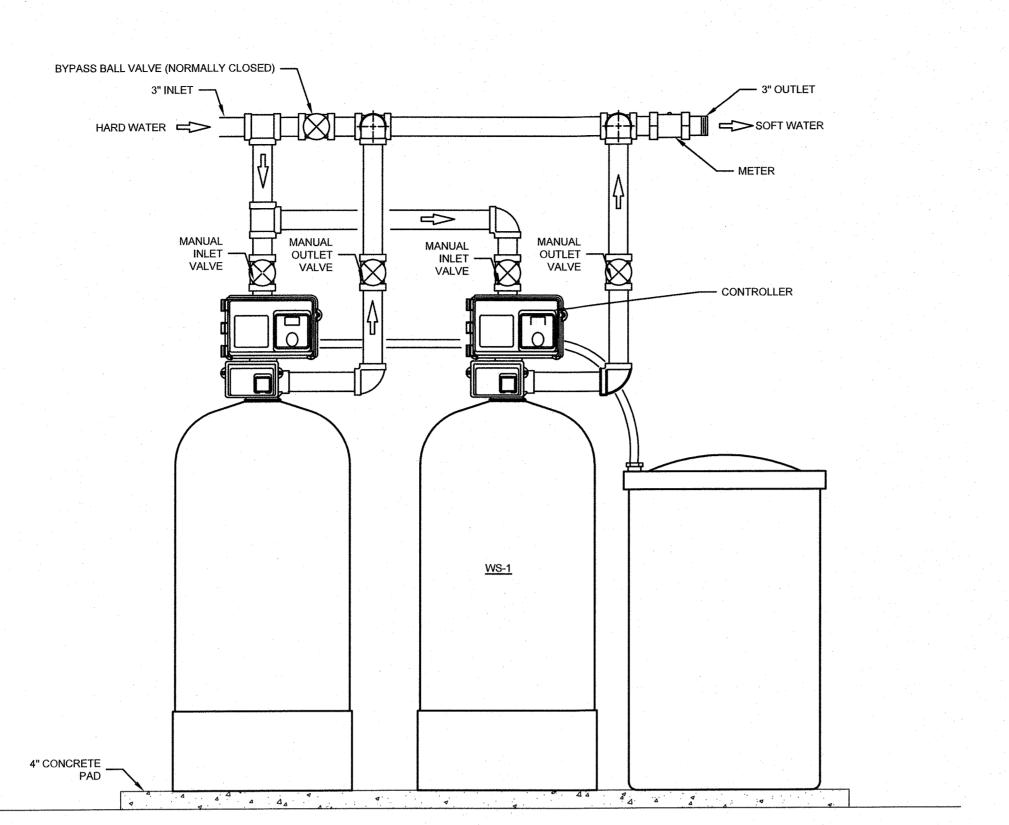

(7) BRINE TANK DIMENSIONS SHOWN ARE FOR THE BRINE TANK MOST COMMONLY SELECTED FOR USE WITH THIS SIZE SYSTEM.

(8) ALTERNATE MANUFACTURERS WILL BE CONSIDERED AND MUST MEET OR EXCEED CONSTRUCTION, PERFORMANCE, AND CAPACITIES OF SPECIFIED SYSTEM.

CONFORM TO LOCAL SANITATION CODES.



PLUMBING LEGEND

VENT THROUGH ROOF

SANITARY SOIL LINE (SAN) SANITARY VENT LINE (V)

COLD WATER LINE (DCW)

HOT WATER RETURN LINE (DHC)

EXISTING NATURAL GAS (EXG)

DOMESTIC COLD WATER

ABOVE FINISHED FLOOR

BELOW FINISHED CEILING

WALL CLEANOUT

DOUBLE CLEANOUT

ELBOW TURNED UP

ELBOW TURNED DOWN

CONNECT TO EXISTING

GAS REGULATOR FROM 2 lbs TO 8 oz. UNLESS NOTHED OTHERWISE (GAS LOAD IN MBTUH)

FLOW IN DIRECTION OF ARROW

WALL HYDRANT / HOSE BIBB FLOOR DRAIN/ FLOOR SINK

CLEANOUT

BALL VALVE

VALVE IN BOX CHECK VALVE GAS COCK

DOMESTIC HOT WATER

ACCESS DOOR

SANITARY SOIL SANITARY VENT NATURAL GAS

EXISTING SANITARY SOIL (EXSAN)

DOMESTIC HOT WATER CIRCULATING

LINE TO BE REMOVED (DEMO-SYSTEM)

EXISTING DOMESTIC COLD WATER (EXDCW)

HOT WATER LINE (DHW)

GAS LINE (G)

FIRE LINE (F)

SYMBOL

VTR •

---- G ----

---DEMO---

EXSAN

EXDCW DCW

DHW

AD

SAN

G

A.F.F.

B.F.C.

MCO ——

CO o

DCO oo

<u>WH/HB</u>——


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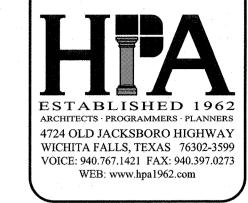
TO BE FLUSH WITH FINISHED GRADE.

VENT -

OUTLET -

DESCRIPTION



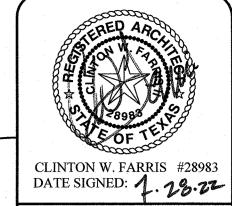



WWW.FINCHERENG.COM

12" CAST IRON MANHOLE RING & TRAFFIC RATED SOLID COVER FLUSH WITH FINISHED GRADE 12" I.D. RIBBED HIGH DENSITY
POLYETHYLENE RISER SECTION, LENGTH CAN VARY, CONTRACTOR CAN CUT TO LENGTH

GREASE INTERCEPTOR DETAIL NO SCALE

VAUGN 1500 GALLON CAPACITY PRECAST CONCRETE GREASE

INTERCEPTOR, OR EQUAL.

24" CAST IRON MANHOLE RING & TRAFFIC RATED -SOLID COVER.

17" CAST IRON MANHOLE

RING & TRAFFIC RATED —

FACTORY —— INSTALLED

SOLID COVER.

24" CAST IRON MANHOLE

CONCRETE APRON

MANHOLE RISERS -

AS NEEDED

INLET -

COMPACT FILL -

PRECAST CONCRETE

W/ 6"X6" MESH

RING & TRAFFIC RATED -

INSTALL GREASE TRAP FAR AWAY ENOUGH FROM BUILDING SO OUTSIDE OF STRUCTURAL COMPRESSION ZONE, REFER TO ARCHITECTURAL

TOP OF MANHOLE COVER CONCRETE APRON ____ W/ 6"X6" MESH -VAUGHN 62 SAMPLING BASIN, OR EQUAL. SAMPLE PORT BASIN DETAIL


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REVISIONS

DESCRIPTION

DATE: 28 JULY 2022



COMMENTS: 1. PROVIDE UPPER ATTACHMENT AS REQUIRED FOR CASES NOT SHOWN HERE. DO NOT INSTALL HANGER INSIDE INSULATION OR OTHERWISE PENETRATE VAPOR BARRIER. DO NOT HANG ONE PIPE FROM ANOTHER EXCEPT IN CHASES. TRAPEZE HANGERS MAY BE USED FOR MULTIPLE PARALLEL PIPES. SLOPE ALL WATER PIPING SLIGHTLY TOWARD DRAINABLE LOCATIONS. HANGER SPACING FOR PIPE SIZE: COPPER: 2"=9' 1½"=8' 1½"=7' 1"=6' ¾"=6' ¾"=5'. CAST IRON: 10' AND ONE NEAR ALL JOINTS, STEEL: 3"=12' 2½"=11' 2"=10' 1 ½"=9' 1"=7' ¾"=6' ½"=5'. LOCATE HANGERS AS CLOSE AS POSSIBLE TO TURNS AND TEES OF PIPE. PROVIDE SUPPLEMENTARY STEEL STRUTS BETWEEN JOISTS IF REQUIRED. LOCATE HANGERS TO TAKE LOAD OFF OF EQUIPMENT CONNECTIONS. ANCHOR WATER PIPE AGAINST SWAYING DUE TO CHANGES IN WATER VELOCITY. PROVIDE SEISMIC BRACING AS REQUIRED BY LOCAL AUTHORITIES. CHAINS OR PERFORATED STRAP IRON OR STEEL IS NOT ACCEPTABLE. DO NOT SUSPEND PIPE FROM JOIST BRACING MEMBERS. REFER TO CODES AND SPECIFICATIONS FOR FURTHER INFORMATION.

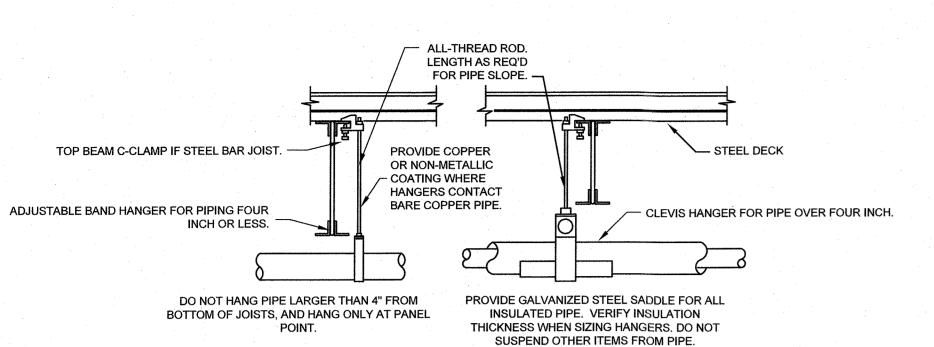PIPE HANGER DETAIL

MICKEL BRONZE SCORIATED TOP


INTERIOR CLEANOUT DETAIL NO SCALE

INSTALL WATER HAMMER -ARRESTOR JUST BEFORE LAST FIXTURE ON BRANCH LINE INSTALL WATER HAMMER ARRESTOR ON ALL FIXTURES WITH QUICK CLOSING VALVES. - INSTALL AN ADDITIONAL WATER HAMMER ARRESTOR IF THE BRANCH LINE IS GREATER THAN 20' LONG. MULTIPLE FIXTURES

				MULTIPLE FIXTURE	<u>S</u>							
PDI	PIPE	FIXTURE	:	WATER SUPPLY FIXTURE UNIT (WSFU)								
SIZE SIZE		UNIT LOAD		FIXTURE	COLD	НОТ						
Α	1/2"	1-11		WATER CLOSET	5	-						
В	3/4"	12-32		URINAL	4	-						
С	1"	33-60		LAVATORY/SINK	1.5	1.5						
D	1-1/4"	61-113		JANITOR'S SINK	3	3						
E	1-1/2"	114-154										
F	2"	154-330										

1. WATER HAMMER ARRESTERS SHALL BE HAVE PISTON AND 0-RING CONSTRUCTION WITH PDI #WH-201, ASSE # 1010 AND ANSI # A112.26.1M CERTIFICATION. INSTALL IN HORIZONTAL OR VERTICAL POSITION, BUT NEVER UPSIDE DOWN. SIZE THE UNITS AS SHOWN PER THE TABLES SHOWN ABOVE.

> WATER HAMMER ARRESTER DETAIL NO SCALE

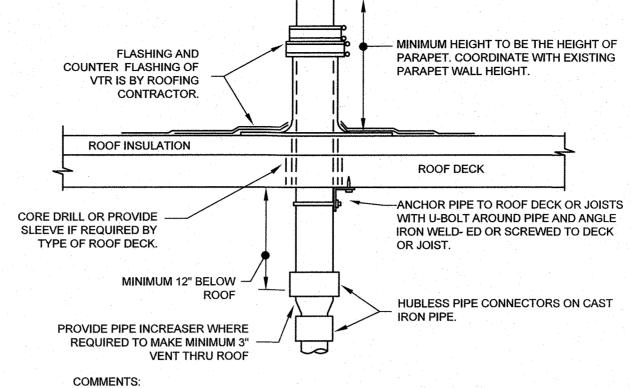


1. REFER TO PLANS FOR VTR PIPE SIZES AND LOCATIONS. LOCATE VTR MINIMUM THREE FEET FROM PROPERTY LINE, OR TEN FEET HORIZONTAL OR THREE FEET VERTICAL ABOVE ANY BUILDING OPENING OR FRESH AIR INTAKE. OR ONE FOOT FROM ANY VERTICAL SURFACE. LOCATE VTR MINIMUM 18" FROM PARAPET, EXPANSION JOINT, EQUIPMENT CURB, ETC. OFFSET IN CEILING SPACE WHERE REQUIRED TO MEET THESE CONDITIONS.

> VENT THRU ROOF (VTR) DETAIL NO SCALE



HIGH PRESSURE

FOR PRESSURE GUAGE

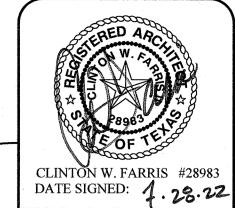





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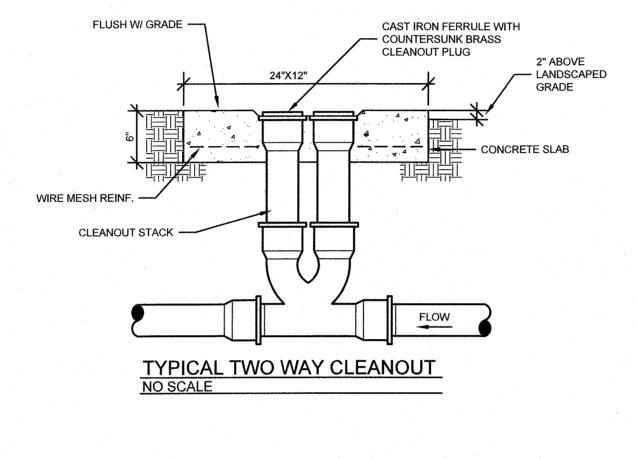
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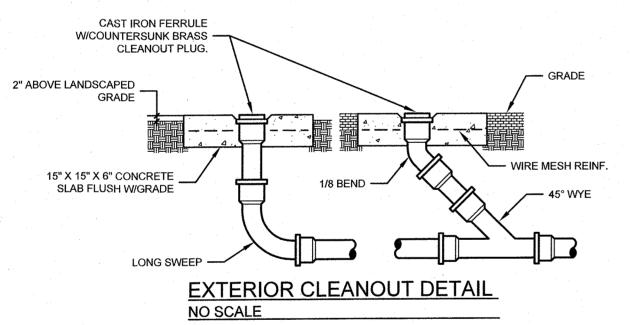
DRAWN BY: FINCHER DATE: 28 JULY 2022 REVISIONS DESCRIPTION


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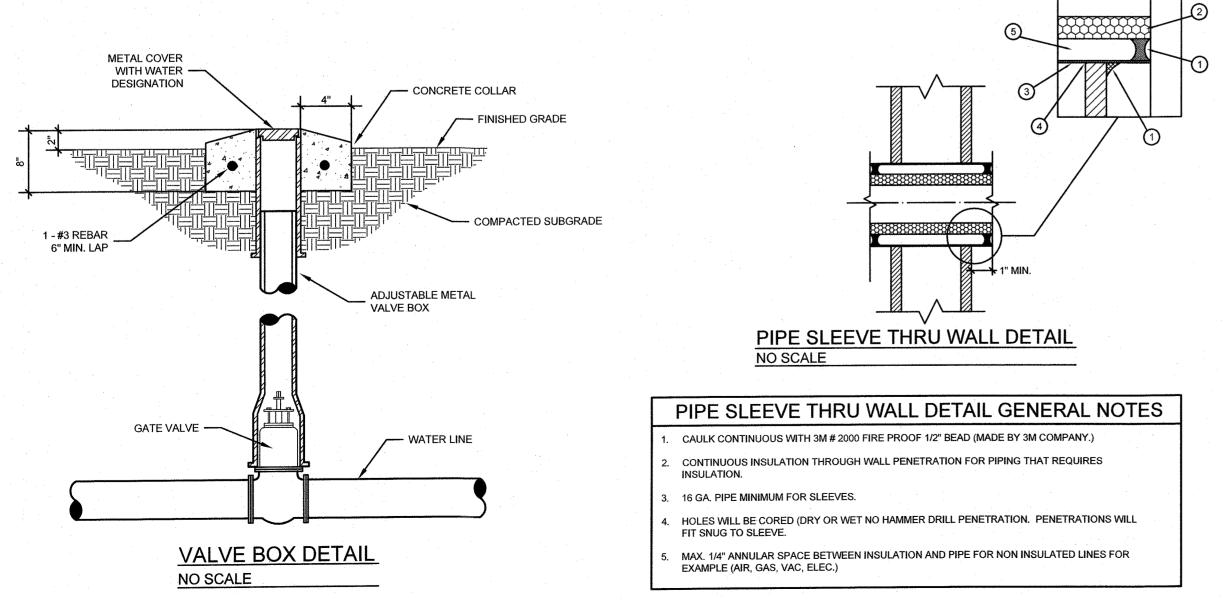
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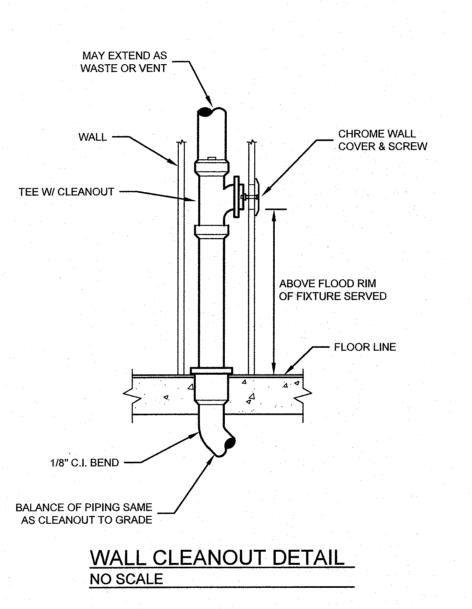
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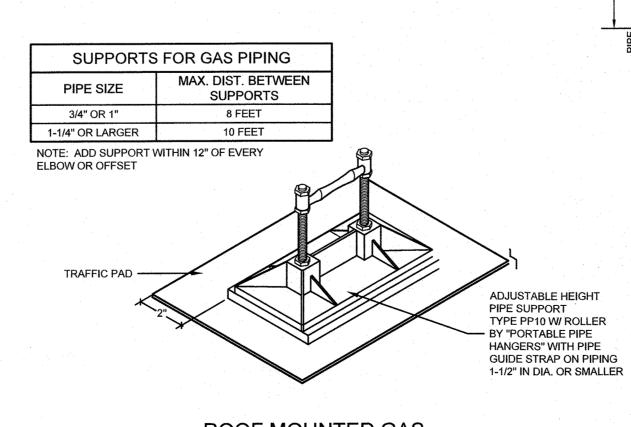












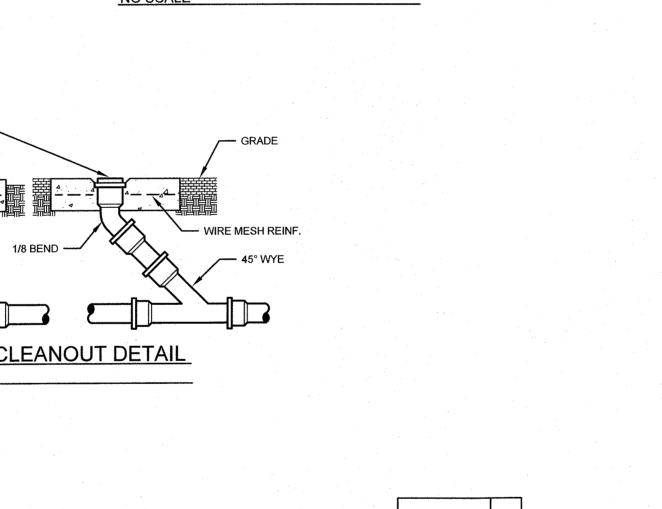

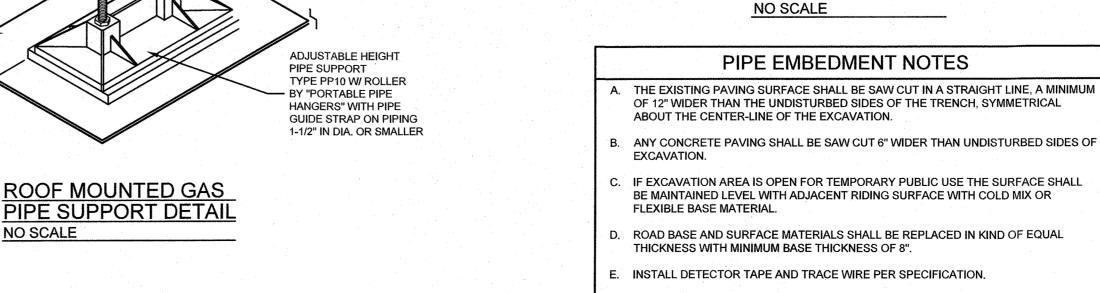

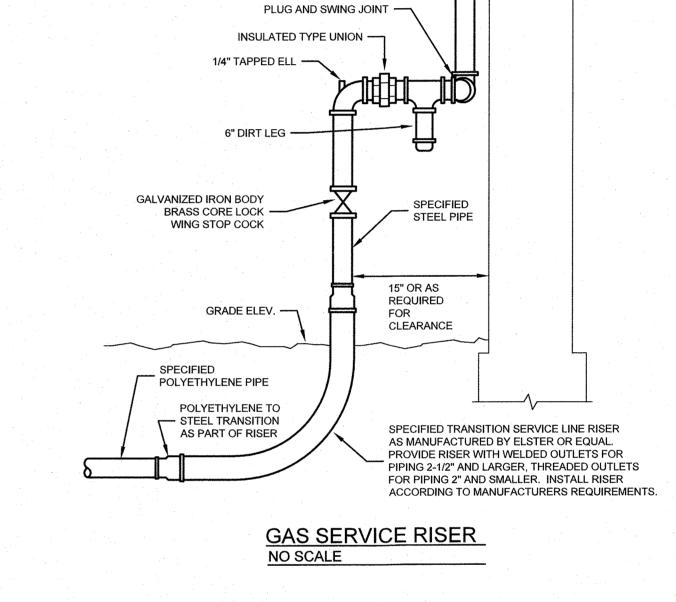

BLDG. WALL -

GAS REGULATOR -

GAS PRESSURE REGULATOR

- MIN. 10 PIPE DIAMETERS ----

LOW PRESSURE

