

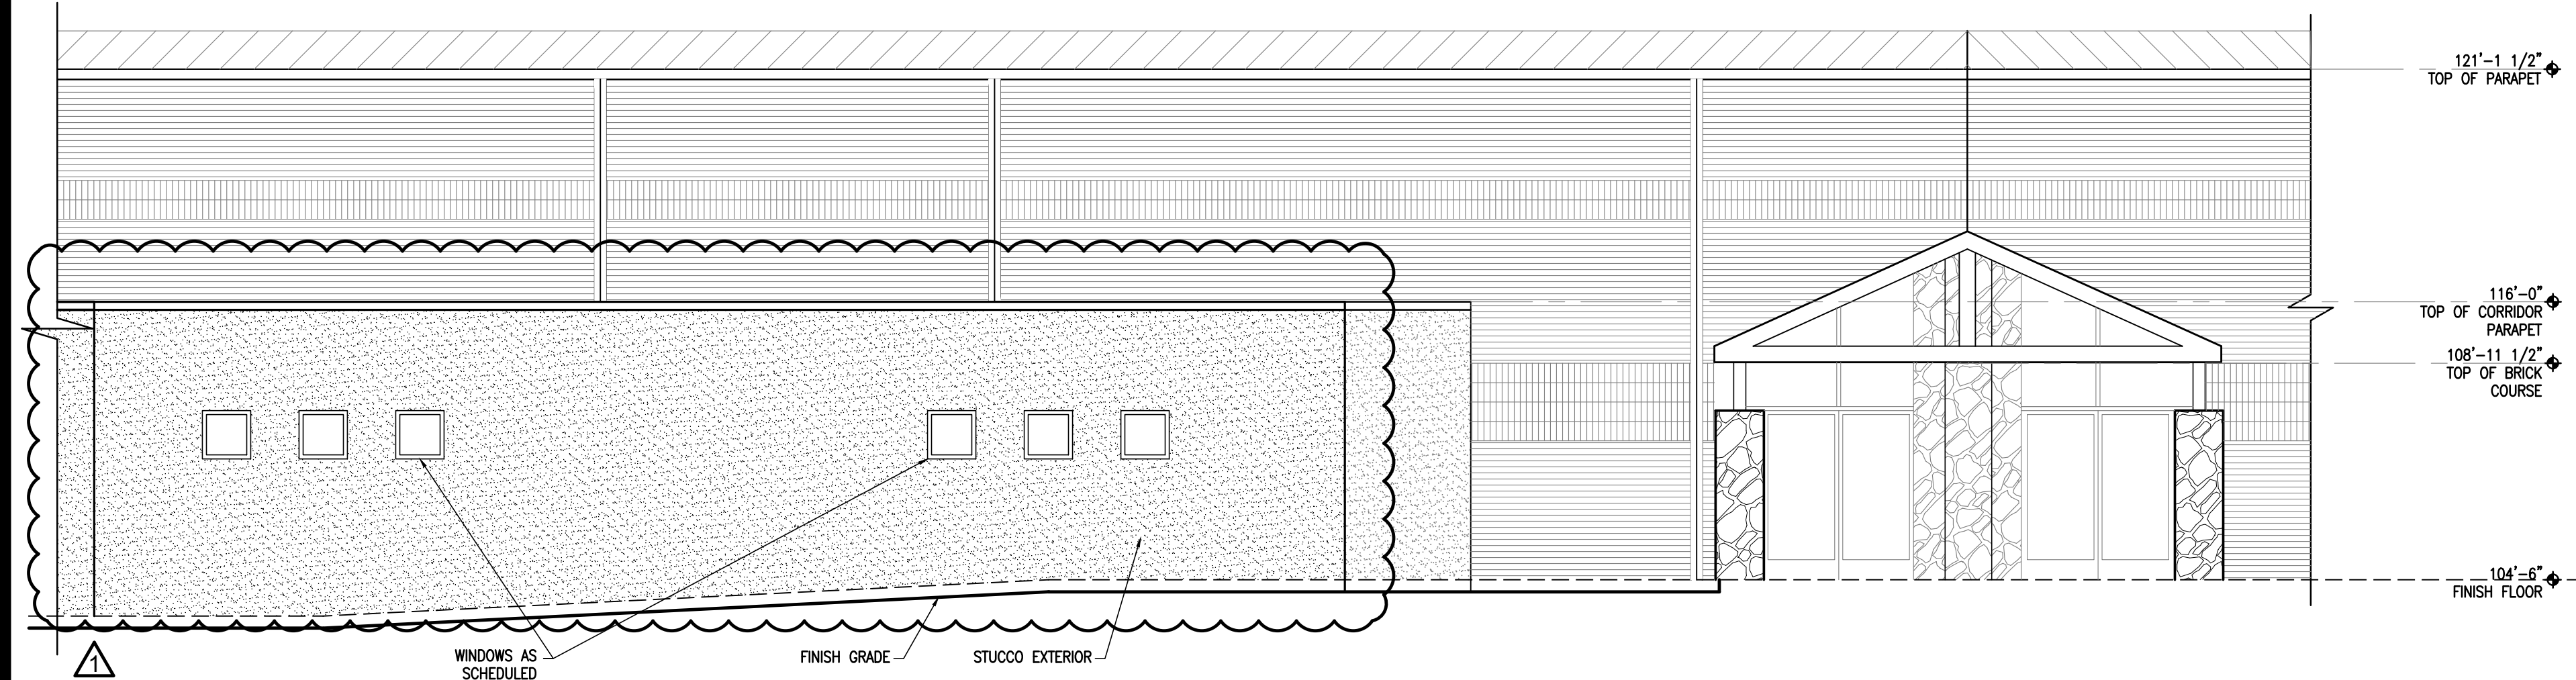


PROSTUD FULL COMPOSITE LIMITING HEIGHTS					
5/8" TYPE X GYPSUM					
WIDTH	STUD MEMBER	DESIGN THICKNESS (IN)	YIELD STRENGTH (KSL)	SPACING (IN)	LATORAL LOAD - 5 PSF
3-5/8"	PROSTUD 25 362PDS125-15	0.0158	50	12	17'-1"
				16	15'-6"
				24	13'-6"
	PROSTUD 20 362PDS125-18	0.0190	70	12	18'-2"
				16	16'-10"
				24	15'-1"
	PROSTUD 30 362PDS125-30	0.0312	33	12	20'-5"
				16	18'-6"
				24	16'-2"
PROSTUD 33 362PDS125-33	0.0346	33	12	21'-2"	
			16	19'-2"	
			24	16'-9"	


PROSTUD NON-COMPOSITE LIMITING HEIGHTS					
5/8" TYPE X GYPSUM					
WIDTH	STUD MEMBER	DESIGN THICKNESS (IN)	YIELD STRENGTH (KSL)	SPACING (IN)	LATORAL LOAD - 5 PSF
3-5/8"	PROSTUD 25 362PDS125-15	0.0158	50	12	12'-5"
				16	10'-9"
				24	8'-9"
	PROSTUD 20 362PDS125-18	0.0190	70	12	14'-6"
				16	13'-2"
				24	10'-9"
	PROSTUD 30 362PDS125-30	0.0312	33	12	17'-4"
				16	15'-9"
				24	13'-9"
PROSTUD 33 362PDS125-33	0.0346	33	12	17'-11"	
			16	16'-3"	
			24	14'-3"	

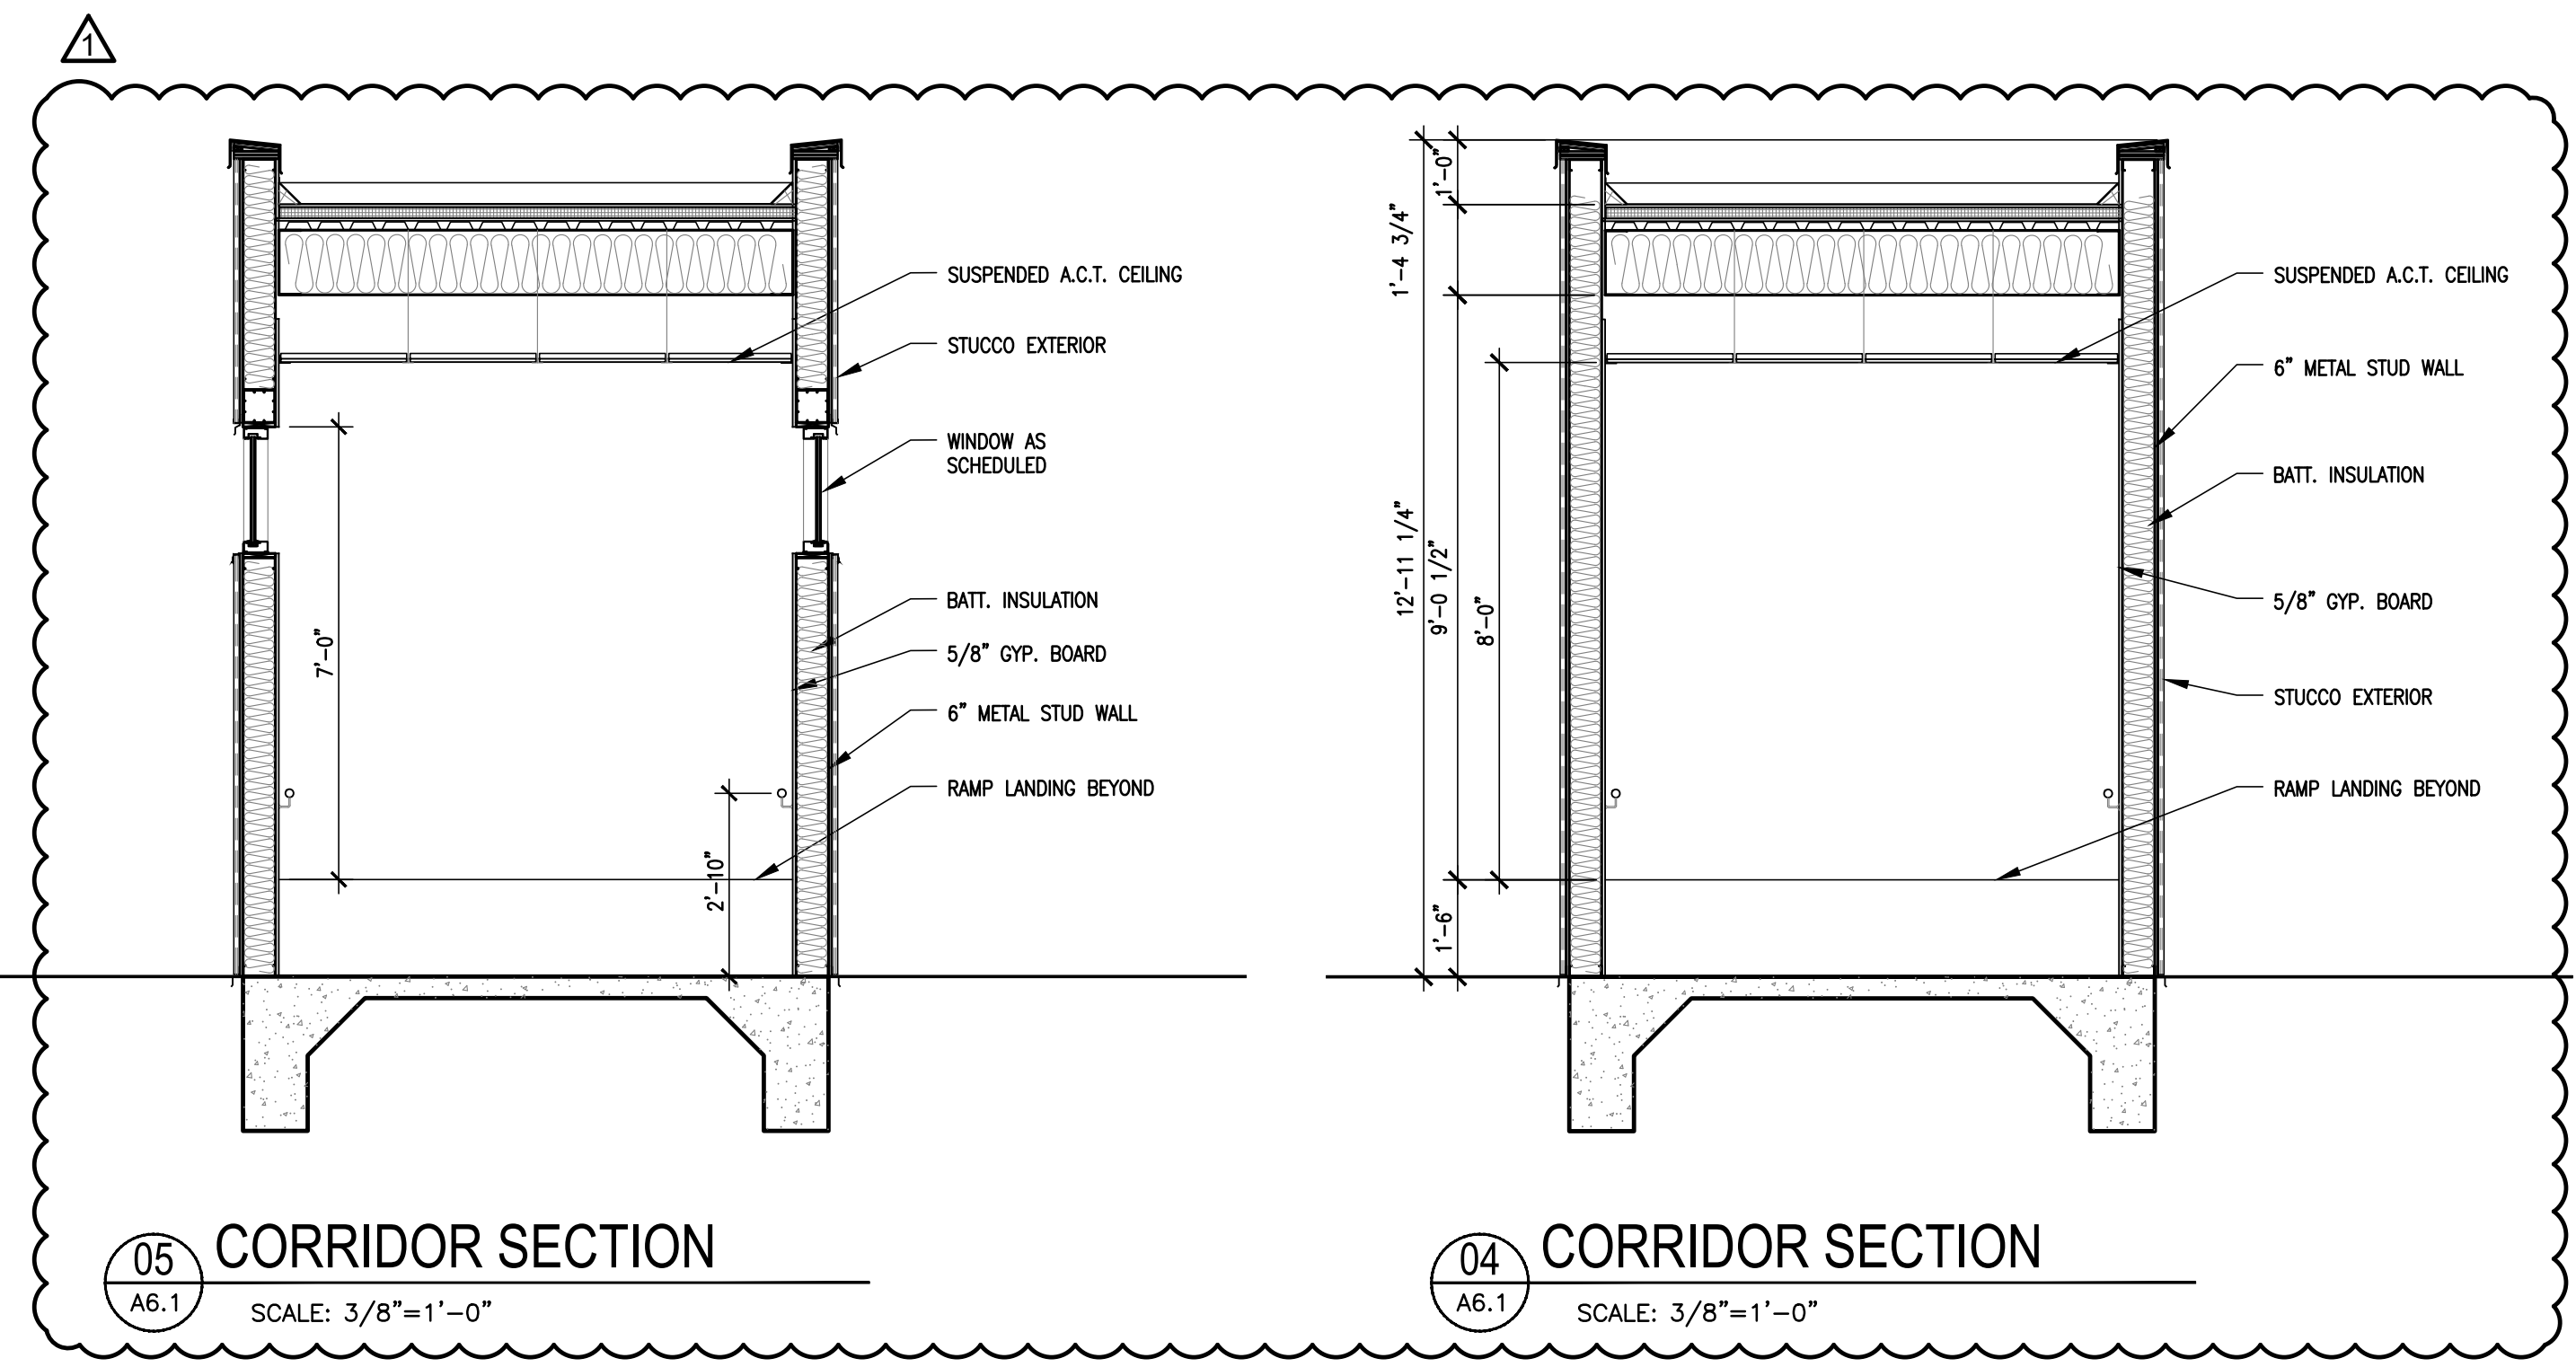


03 SOUTHEAST ELEVATION
A6.1 SCALE: 3/16"=1'-0"

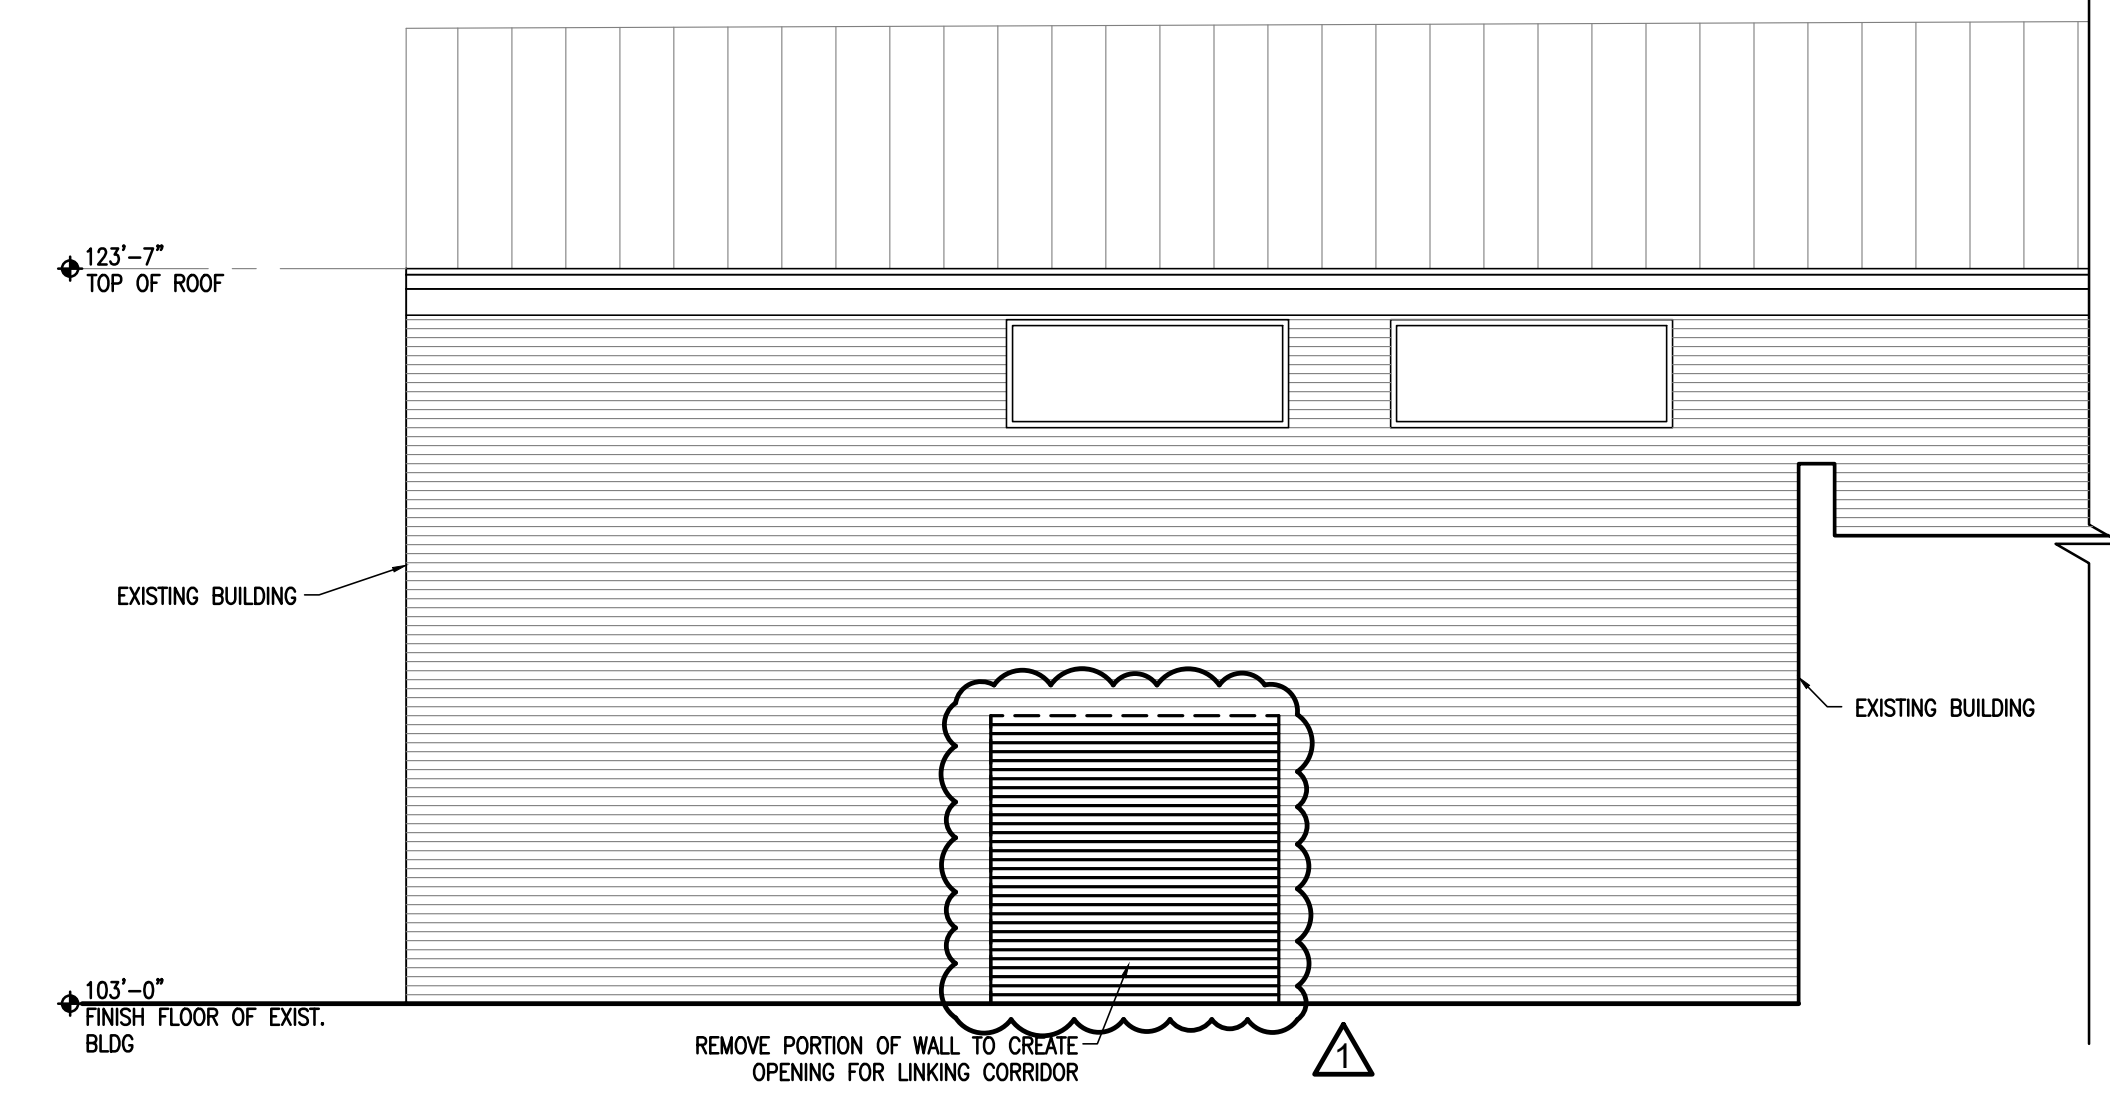


02 NORTHWEST DEMO ELEVATION
A6.1 SCALE: 3/16"=1'-0"

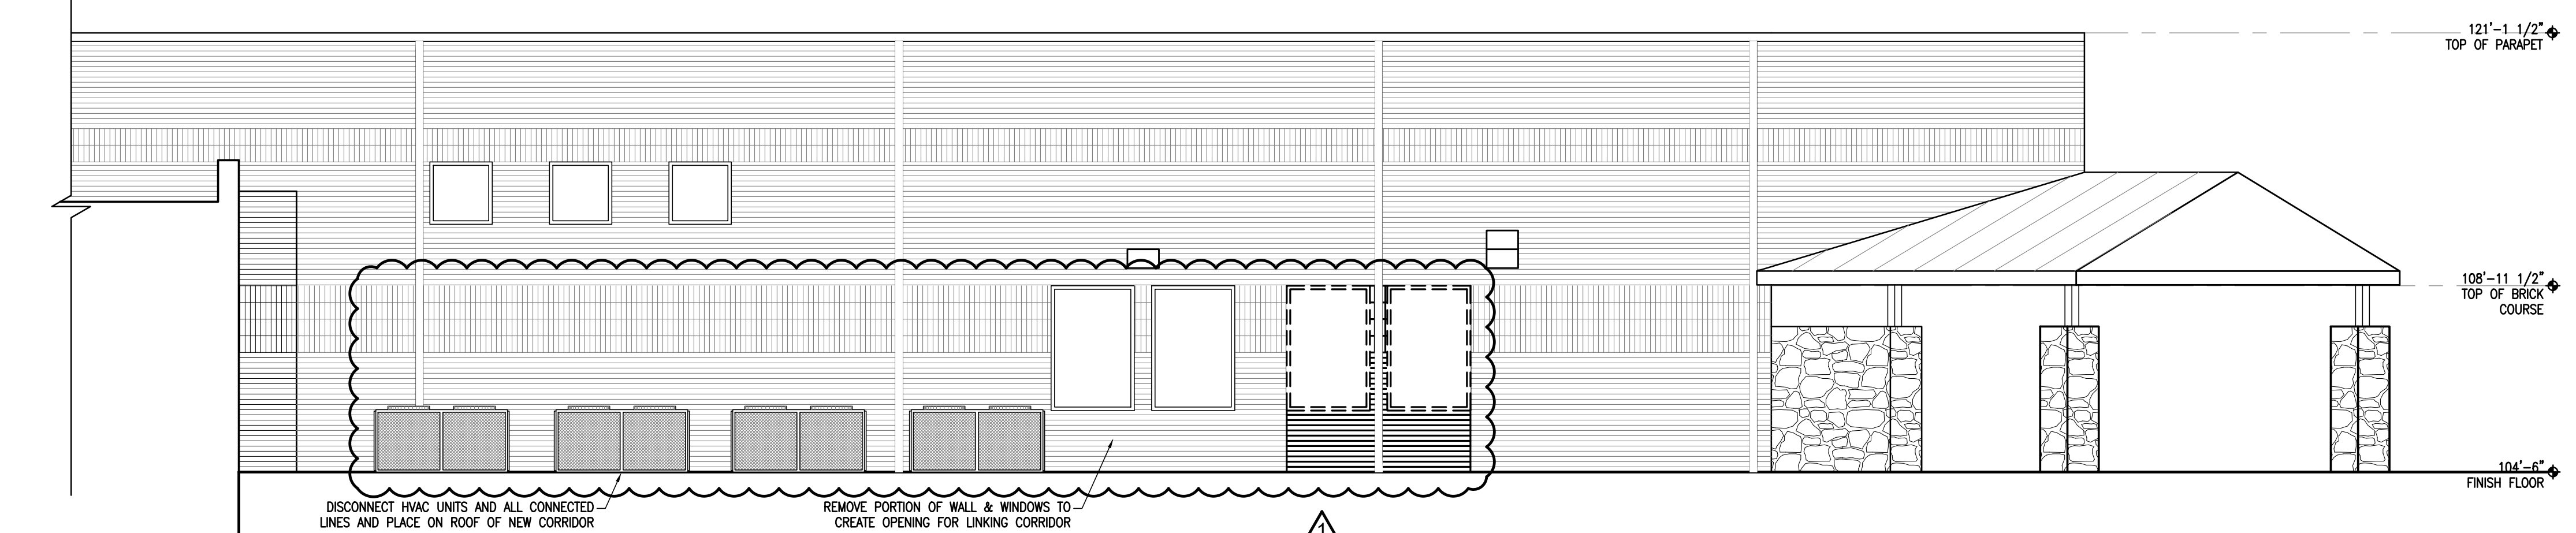

01 SOUTHEAST DEMO ELEVATION
A6.1 SCALE: 3/16"=1'-0"

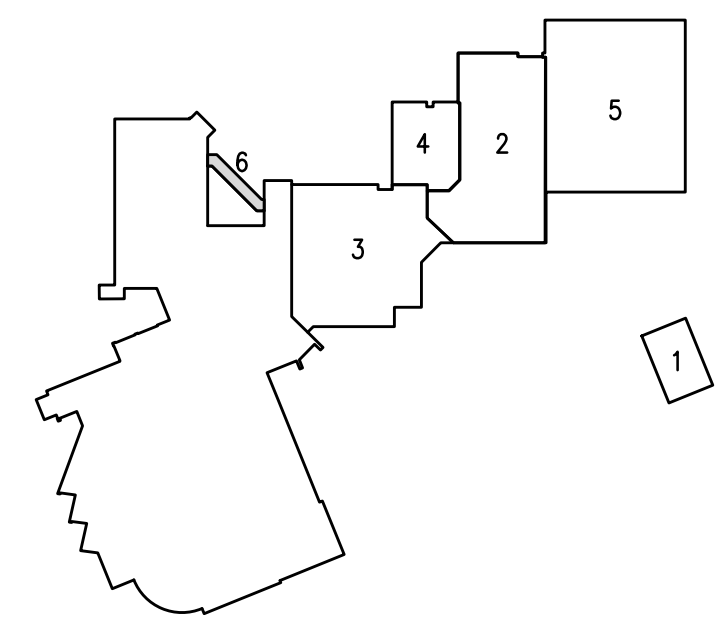

KEY PLAN
NORTH

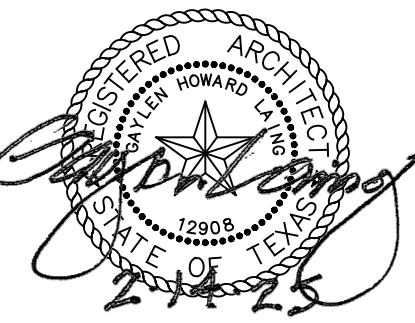

DATE: 08/14/24
ISSUE:
-
REVISION:
▲ REVISED 03-10-25
-
-
SHEET TITLE:

PHASE 6
EXT. ELEVATIONS